TOWNSHIP OF CHATHAM, MORRIS COUNTY, NEW JERSEY

PEDESTRIAN SAFETY AND ADA IMPROVEMENTS

MAYOR
Mayor Ashley Felice


TOWNSHIP COMMITTEE

Mark Hamilton
Stacy Ewald
Mike Choi
Mark Lois

TOWNSHIP ADMINISTRATOR
Ziad Andrew Shehady

TOWNSHIP ENGINEER John K. Ruschke, P.E.

PROJECT LOCATION-

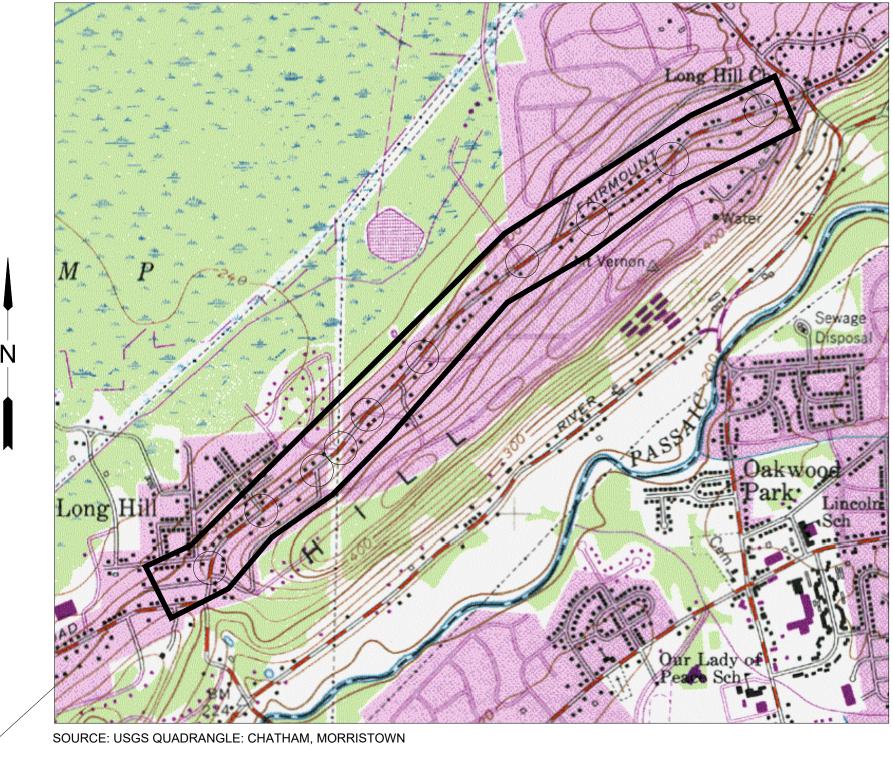

TOTAL LENGTH OF THE PROJECT AREA = 9000 LF OR 1.7 MILES

USGS MAP

0 1000 2000

SCALE: 1" = 1000'

AUGUST 2023

M

MOTT MACDONALD

JOHN K. RUSCHKE

Professional Engineer - N.J. Lic. No. 24GE0037148

THE NEW JERSEY DEPARTMENT OF TRANSPORTATION STANDARD SPECIFICATIONS FOR ROAD AND BRIDGE CONSTRUCTION 2019 EDITION WITH AMENDMENTS THERETO TO GOVERN.

INDEX OF DRAWINGS:

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TITLE SHEET

SITE PLAN

D-001-D004 CONSTRUCTION DETAILS

T-001-T005 TRAFFIC CONTROL DETAILS

GENERAL NOTES & DETAILS

OVERALL SITE PLAN

GENERAL NOTES:

- 1. ALL WORK SHALL BE PERFORMED IN ACCORDANCE WITH THESE PLANS AND SPECIFICATIONS AND ALL APPLICABLE REQUIREMENTS AND STANDARDS OF THE COUNTY OF MORRIS.
- 2. HOURS OF OPERATION FOR THIS PROJECT SHALL BE WITHIN THE HOURS OF 9:00 AM TO 4:00 PM UNLESS PRIOR APPROVAL IS GRANTED DURING THE PRECONSTRUCTION MEETING.
- 3. THE ENGINEER NOR HIS REPRESENTATIVES ARE RESPONSIBLE FOR JOB SAFETY. JOB SAFETY AND THE SAFETY OF THE PUBLIC IS THE SOLE RESPONSIBILITY OF THE CONTRACTOR.
- 4. THE CONTRACTOR SHALL CONTACT NJ ONE CALL (1-800-272-1000) PRIOR TO THE COMMENCEMENT OF ANY WORK.
- 5. MINIMUM, ONE WEEK PRIOR TO THE START OF THE PROJECT, CONTRACTOR SHALL HAVE PROPER ROAD CONSTRUCTION SIGNS IN PLACE, AS DESIGNATED AND APPROVED BY THE ENGINEER.
- 6. INLETS AND MANHOLES TO BE RESET SHALL INCLUDE, IF NECESSARY, REPLACING OF ANY DETERIORATING BLOCK OR BRICK FOUND IN THE UPPER THREE COURSES OF THE STRUCTURE.
- 7. PRICE BID FOR RECONSTRUCT AND RESET INLET OR MANHOLE TO INCLUDE RESETTING OF CASTING TO APPROPRIATE ELEVATION IF REQUIRED.
- 8. RESPECTIVE UTILITY COMPANIES SHALL BE RESPONSIBLE FOR THE RELOCATION OF THEIR STRUCTURES AND THE RAISING OF THEIR VALVES, BOXES, AND MANHOLES. CONTRACTOR TO COORDINATE WITH UTILITY COMPANIES TO IDENTIFY ANY BURIED CASTINGS OR VALVES. REGARDLESS OF RESPONSIBILITY THE CONTRACTOR SHALL ENSURE THAT ALL VALVES, BOXES, AND MANHOLES HAVE BEEN IDENTIFIED AND RAISED.
- 9. ALL PROJECTS WILL BE SUBJECT TO THE HOLIDAY SCHEDULE AS RECOGNIZED BY THE COUNTY OF MORRIS.
- 10. ALL NEW CURB PIECES TO CONFORM TO CAMPBELL TYPE 'N-Eco' OR EQUIVALENT, WITH "DUMP NO WASTE DRAINS TO WATERWAYS" CAST INTO ALL CURB PIECES AND BICYCLE SAFE GRATES.
- 11. ANY INLET CONTAINING AN INLET RISER AND REQUIRING SPACERS FOR CURB PIECES, COST OF SPACERS AND INSTALLATION SHALL BE INCLUDED IN PRICE BID FOR CURB PIECE, CONTRACTOR TO DETERMINE ALL LOCATIONS. EXISTING RISERS AND SPACERS IN INLETS TO BE RECONSTRUCTED OR RESET SHALL BE REMOVED AND CASTINGS SET TO PROPER ELEVATION.
- 12. WHERE REPLACING SIGN POST, PROTECT/REUSE EXISTING SIGN. SIGNS DAMAGED BY CONTRACTOR ARE TO BE REPLACED AT NO ADDITIONAL COST.
- 13. CONTRACTOR IS RESPONSIBLE FOR CONSTRUCTION LAYOUT AS NECESSARY.
- 14. ALL SIGNAGE AND LANE STRIPING IS TO BE INSTALLED IN ACCORDANCE WITH THE MOST CURRENT VERSION OF THE MANUAL ON UNIFORM TRAFFIC CONTROL DEVICES (MUTCD).
- 15. AT NO ADDITIONAL COST, THE CONTRACTOR IS RESPONSIBLE TO APPLY FOR AND OBTAIN A ROAD OPENING PERMIT FROM THE COUNTY OF MORRIS. INSURANCE CERTIFICATE AND A PERFORMANCE BOND MEETING THE COUNTY REQUIREMENTS SHALL BE SUBMITTED.

CURB NOTES:

- 1. CONSTRUCTION OF ALL CURBS SHALL CONFORM TO NJDOT STANDARDS AND SPECIFICATIONS FOR ROAD AND BRIDGE CONSTRUCTION, 2007, SECTION 607, AND SUPPLEMENTS THERETO, AND SHALL MEET THE TOWNSHIP ENGINEER'S APPROVAL. ALL CONCRETE TO BE USED SHALL BE CLASS B AS SPECIFIED IN NJDOT STANDARDS AND SPECIFICATIONS THERETO.
- 2. GRANITE BLOCKS SHALL HAVE A 10 INCH TO 12 INCH VERTICAL LENGTH.
- 3. CURBS SHALL BE SET IN A CLASS B CONCRETE BASE, AT LEAST FOUR INCHES THICK IN FRONT AND REAR OF GRANITE BLOCK AND AT LEAST 6 INCHES THICK BELOW THE BLOCK. THE COMBINED BLOCK AND CONCRETE BASE SHALL HAVE A MINIMUM VERTICAL DIMENSION OF 18 INCHES.
- 4. CURBS SHALL HAVE A SIX INCH EXPOSED VERTICAL FACE ABOVE THE FINISHED PAVEMENT SURFACE.
- 5. JOINTS SHALL MEASURE 3/8" INCH TO 1/2" IN WIDTH.
- 6. THE CURB HEIGHT AT ALL DRIVEWAY OPENINGS SHALL BE LOWERED TO A POINT TWO INCHES ABOVE THE FINISHED SURFACE.
- 7. THE CURBING SHALL BE DESIGNED TO PROVIDE BARRIER FREE CURB RAMPS CONSTRUCTED IN ACCORDANCE WITH DESIGN STANDARDS FOR CURB RAMPS FOR THE PHYSICALLY HANDICAPPED OF THE NEW JERSEY DEPARTMENT OF TRANSPORTATION.

SIDEWALK NOTES:

- 1. A MINIMUM WALKWAY WIDTH OF FOUR FEET SHALL BE CONSTRUCTED IN ACCORDANCE WITH THE REQUIREMENTS OF THE TOWNSHIP ENGINEER IN THE CONFORMANCE WITH CHAPTER 19 OF THE CODE OF THE TOWNSHIP OF CHATHAM.
- 2. WHERE EXTRA WIDTH HAS BEEN DEDICATED FOR WIDENING OF EXISTING STREETS, LOTS SHALL BEGIN WITH SUCH NEW LINE AND ALL SETBACKS SHALL BE MEASURED FROM SUCH NEW LINE.
- 3. CURBING SHALL BE REPAIRED WHEREVER DAMAGED DURING CONSTRUCTION AT NO ADDITIONAL COST. BELGIAN (GRANITE) BLOCK CURBS SHALL BE USED ON ALL TOWNSHIP STREETS ACCORDING TO THE FOLLOWING STANDARDS:
- 3.1. CONSTRUCTION OF ALL CURBS SHALL CONFORM TO NJDOT STANDARDS AND SPECIFICATIONS FOR ROAD AND BRIDGE CONSTRUCTION, 2007, SECTION 607, AND SUPPLEMENTS THERETO, AND SHALL MEET THE TOWNSHIP ENGINEER'S APPROVAL. ALL CONCRETE TO BE USED SHALL BE CLASS B AS SPECIFIED IN NJDOT
- 3.2. GRANITE CURBS SHALL HAVE A 10 INCH TO 12 INCH VERTICAL LENGTH.
- CURBS SHALL BE SET IN A CLASS BE CONCRETE BASE AT LEAST FOUR INCHES THICK IN FRONT AND REAR OF THE GRANITE BLOCK AND AT LEAST 6 INCHES
- THICK BELOW THE BLOCK. THE COMBINED BLOCK AND CONCRETE BASE SHALL HAVE A MINIMUM VERTICAL DIMENSION OF 18 INCHES.
- 3.4. CURBS SHALL HAVE A SIX INCH EXPOSED VERTICAL FACE ABOVE THE FINISHED PAVEMENT SURFACE.

3.5. JOINTS SHALL MEASURE $\frac{3}{8}$ " TO $\frac{1}{2}$ " IN WIDTH.

- 3.6. THE CURB HEIGHT AT ALL DRIVEWAY OPENINGS SHALL BE LOWERED TO A POINT TWO INCHES ABOVE THE FINISHED PAVEMENT.
- 3.7. THE CURBING SHALL BE DESIGNED TO PROVIDE BARRIER FREE CURB RAMPS CONSTRUCTED IN ACCORDANCE WITH THE DESIGN STANDARDS FOR CURB RAMPS FOR THE PHYSICALLY HANDICAPPED OF THE NEW JERSEY DEPARTMENT OF TRANSPORTATION.

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TOWNSHIP OF CHATHAM MORRIS COUNTY, NEW JERSEY

Rev Date

Drawn Description

JOHN K. RUSCHKE PROFESSIONAL ENGINEER LIC. NO. 24GE0037148 Date 08-03-2023

Project Number

507393101-001

Designed 05/23 Eng check 05/23 Coordination Drawn 05/23 05/23 Dwg check Approved Scale at ARCH D Status Security N.T.S. STD Rev0 Drawing Number

G-002

CHATHAM TOWNSHIP PEDESTRIAN SAFETY AND ADA **IMPROVEMENTS**

GENERAL NOTES & DETAILS

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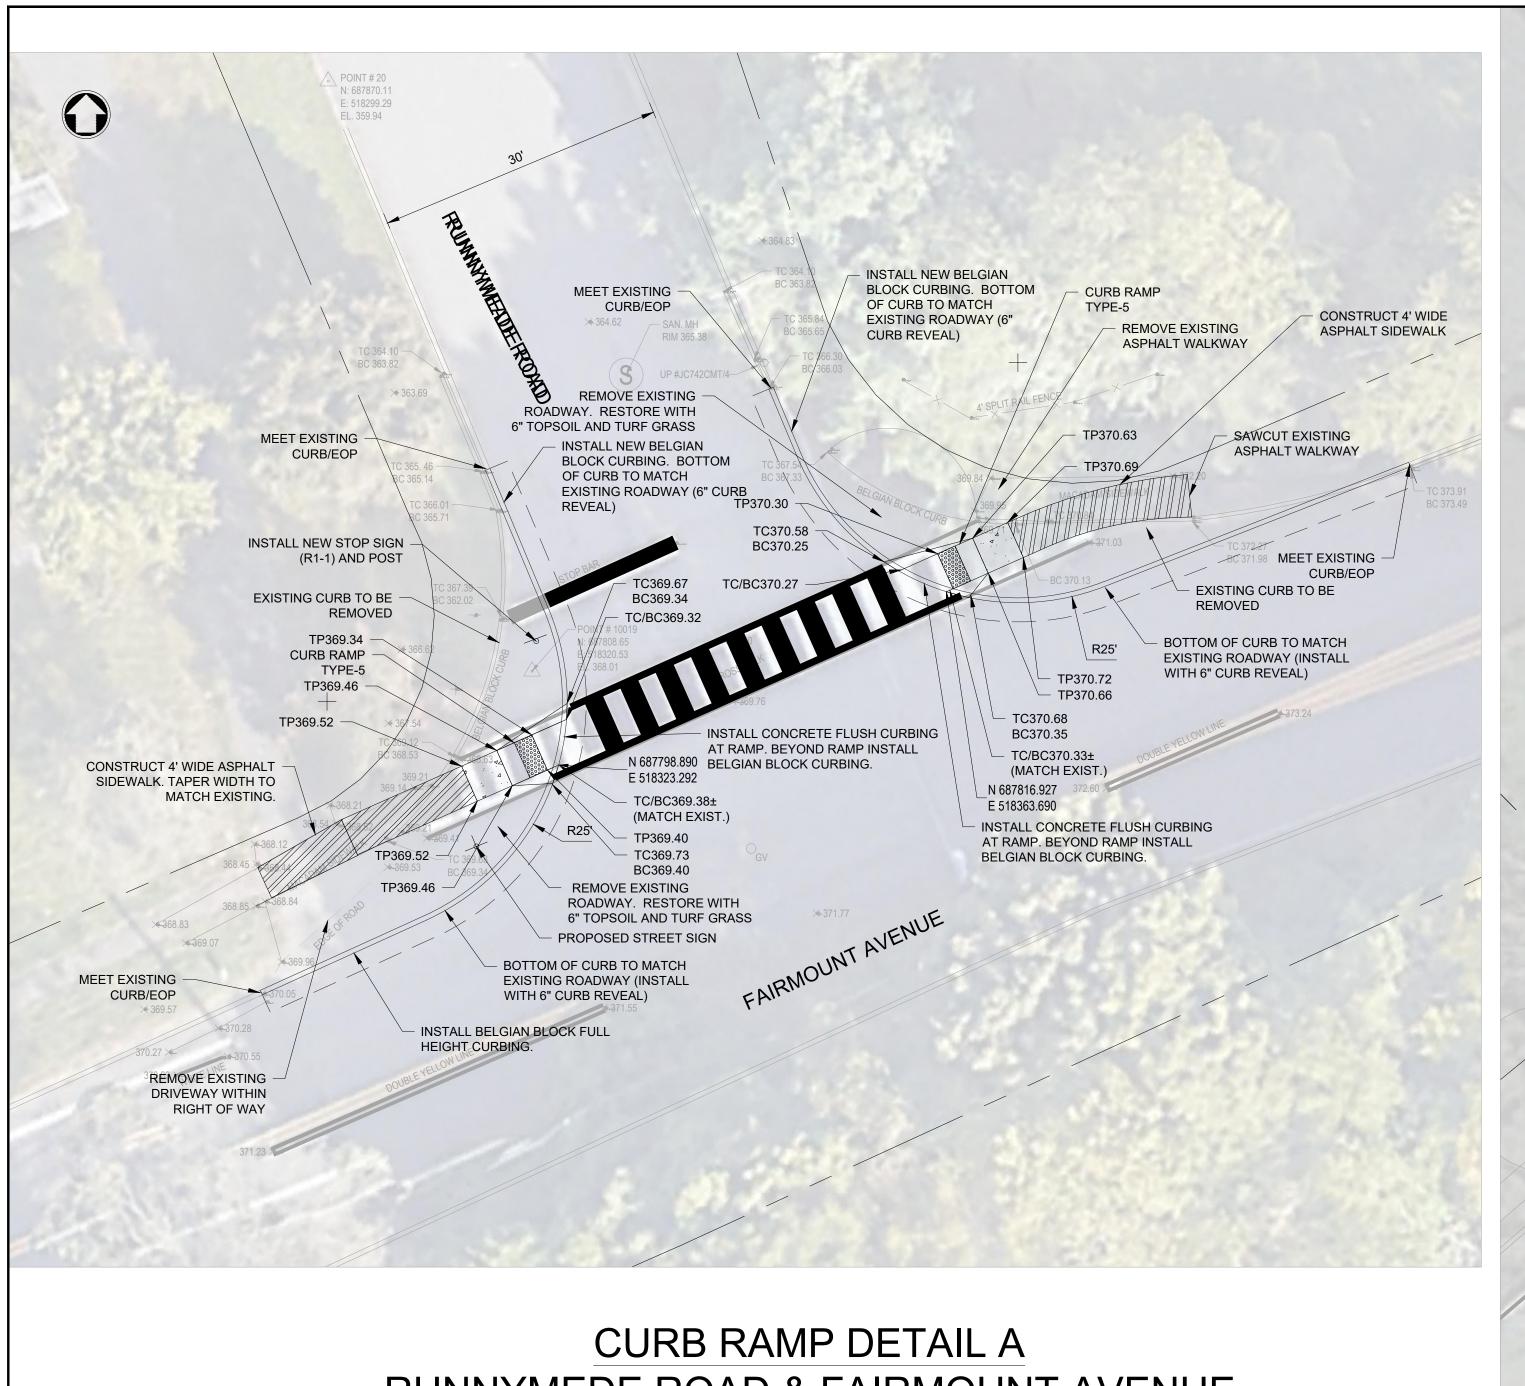
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Project Number 507393101-001 Drawn Description Rev Date


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OVERALL SITE PLAN



RUNNYMEDE ROAD & FAIRMOUNT AVENUE



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TOWNSHIP OF CHATHAM MORRIS COUNTY, NEW JERSEY

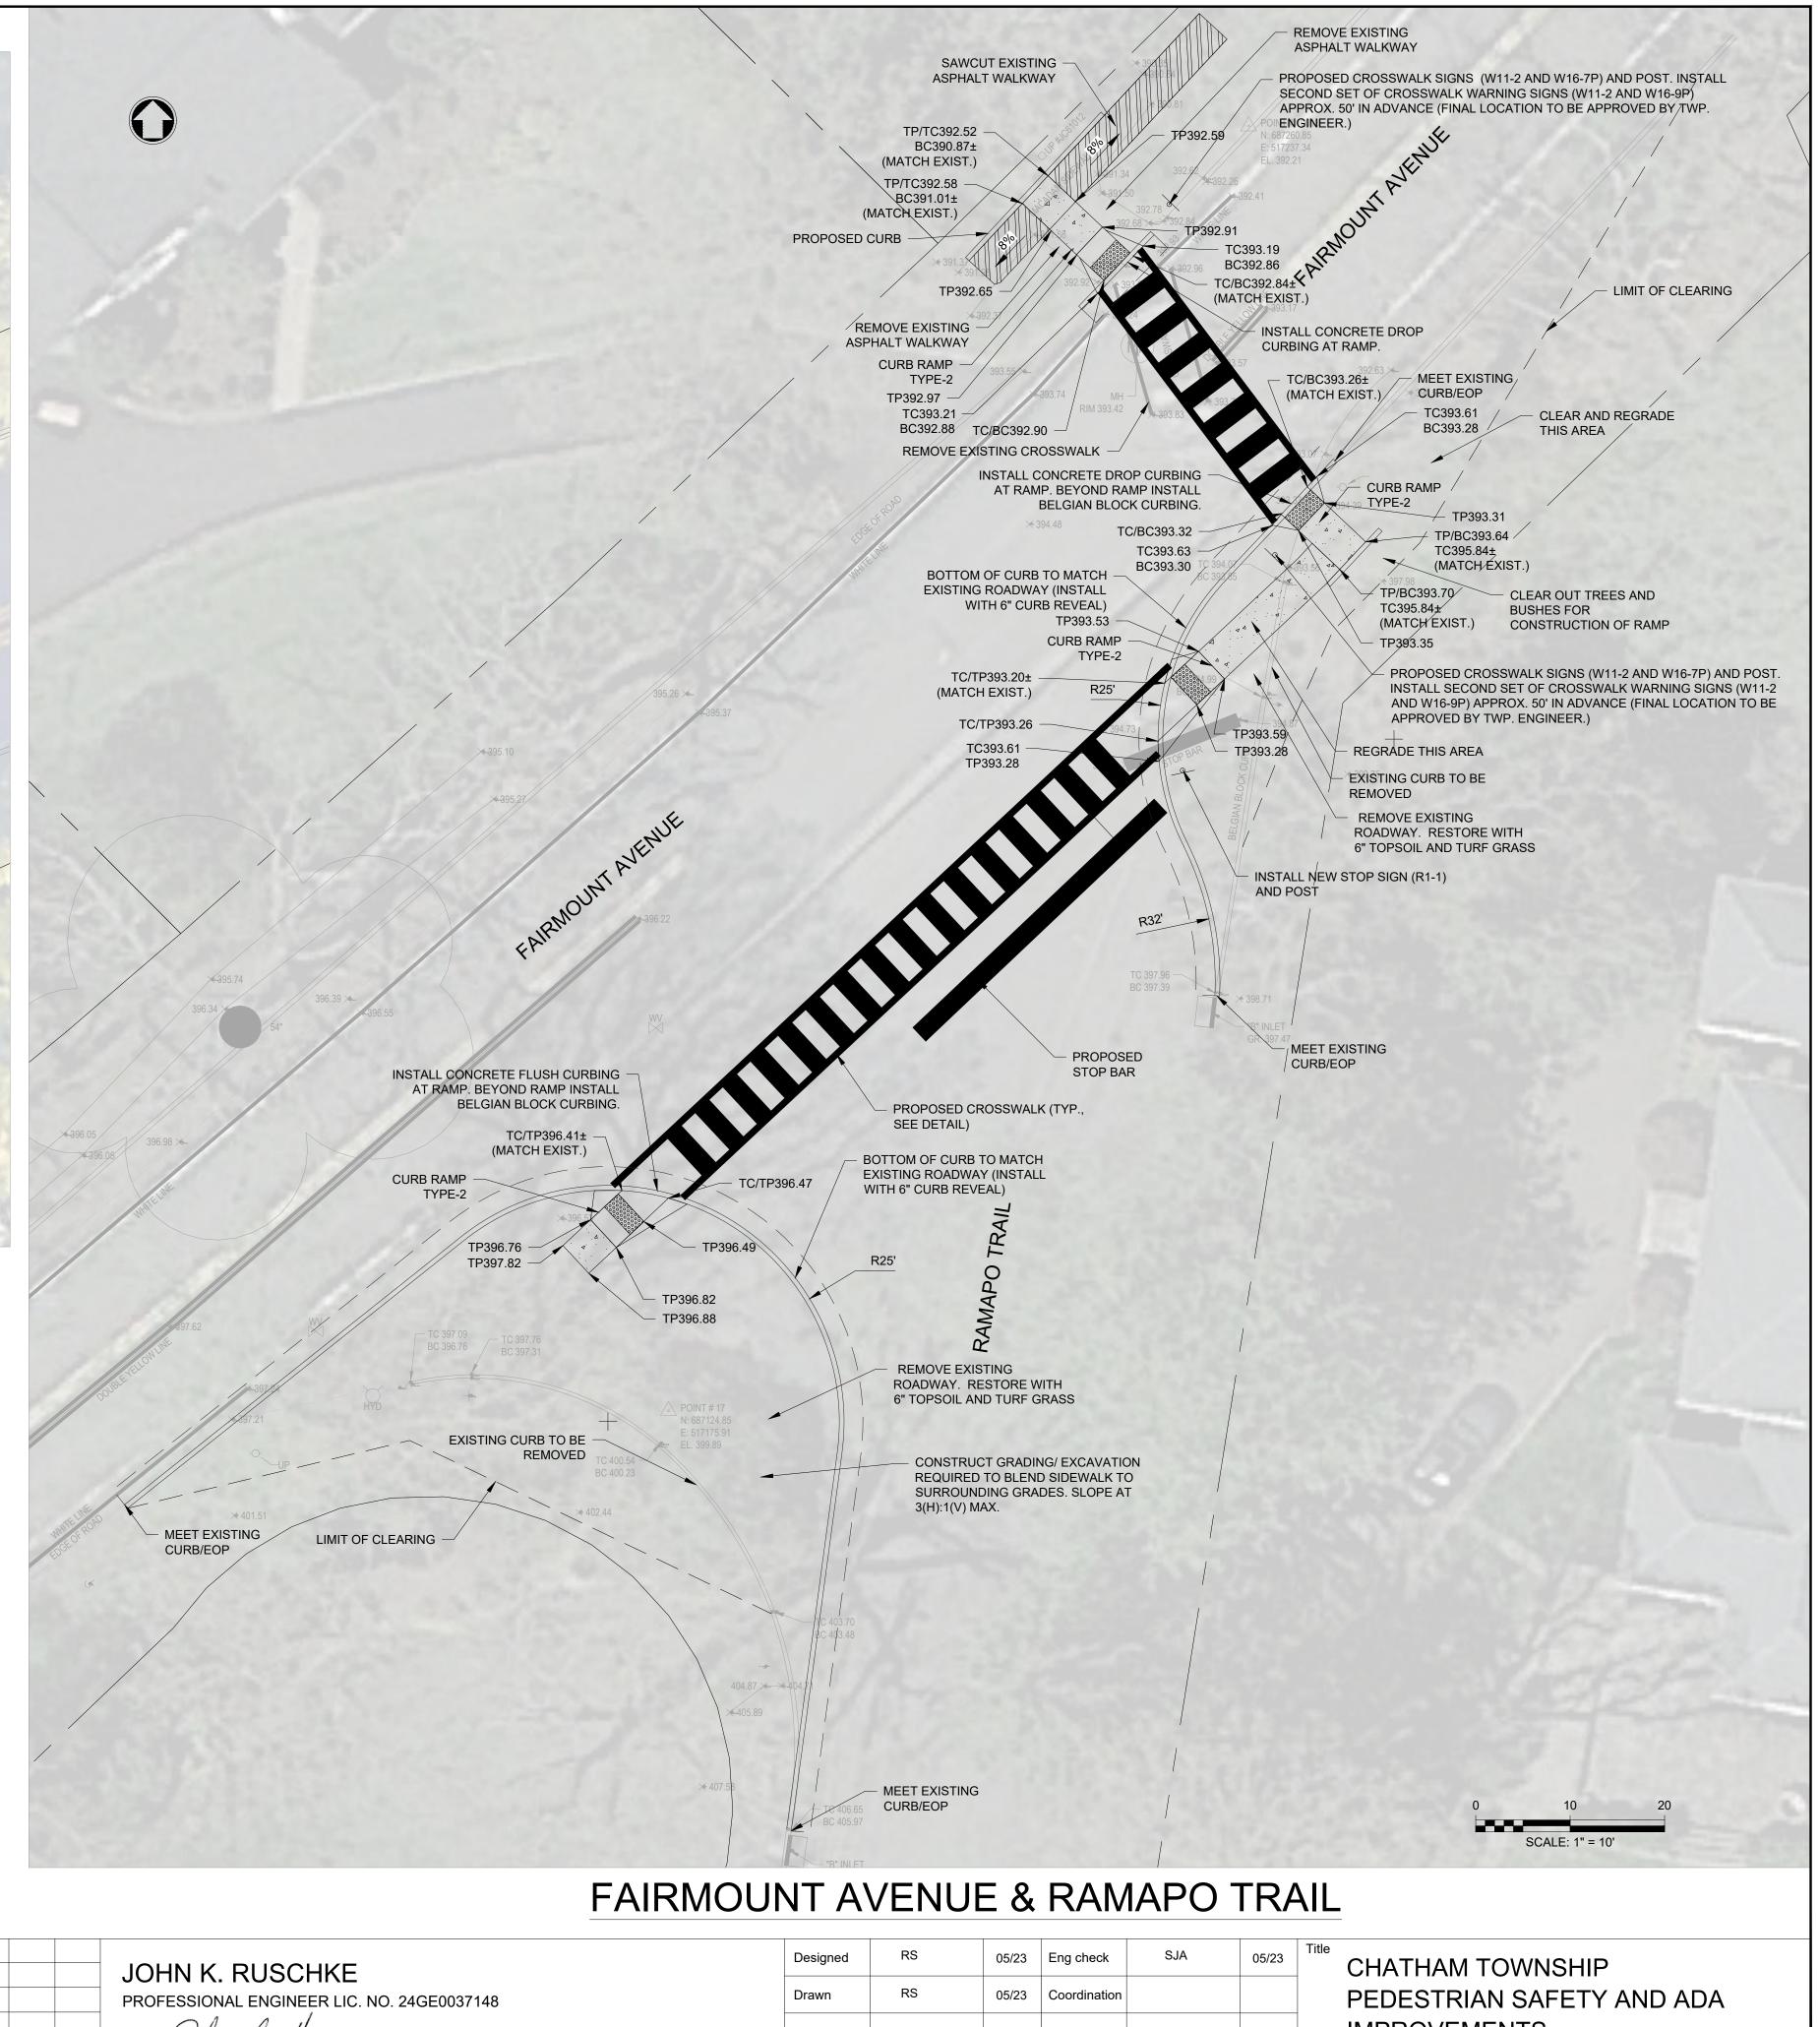Project Number 507393101-001 Drawn Description

Date <u>08-03-2023</u>

05/23 Dwg check Scale at ARCH D 1"=10' STD Rev0 Drawing Number

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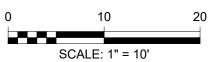
IMPROVEMENTS





FAIRMOUNT AVENUE & ROCKLEDGE TRAIL

507393101-001



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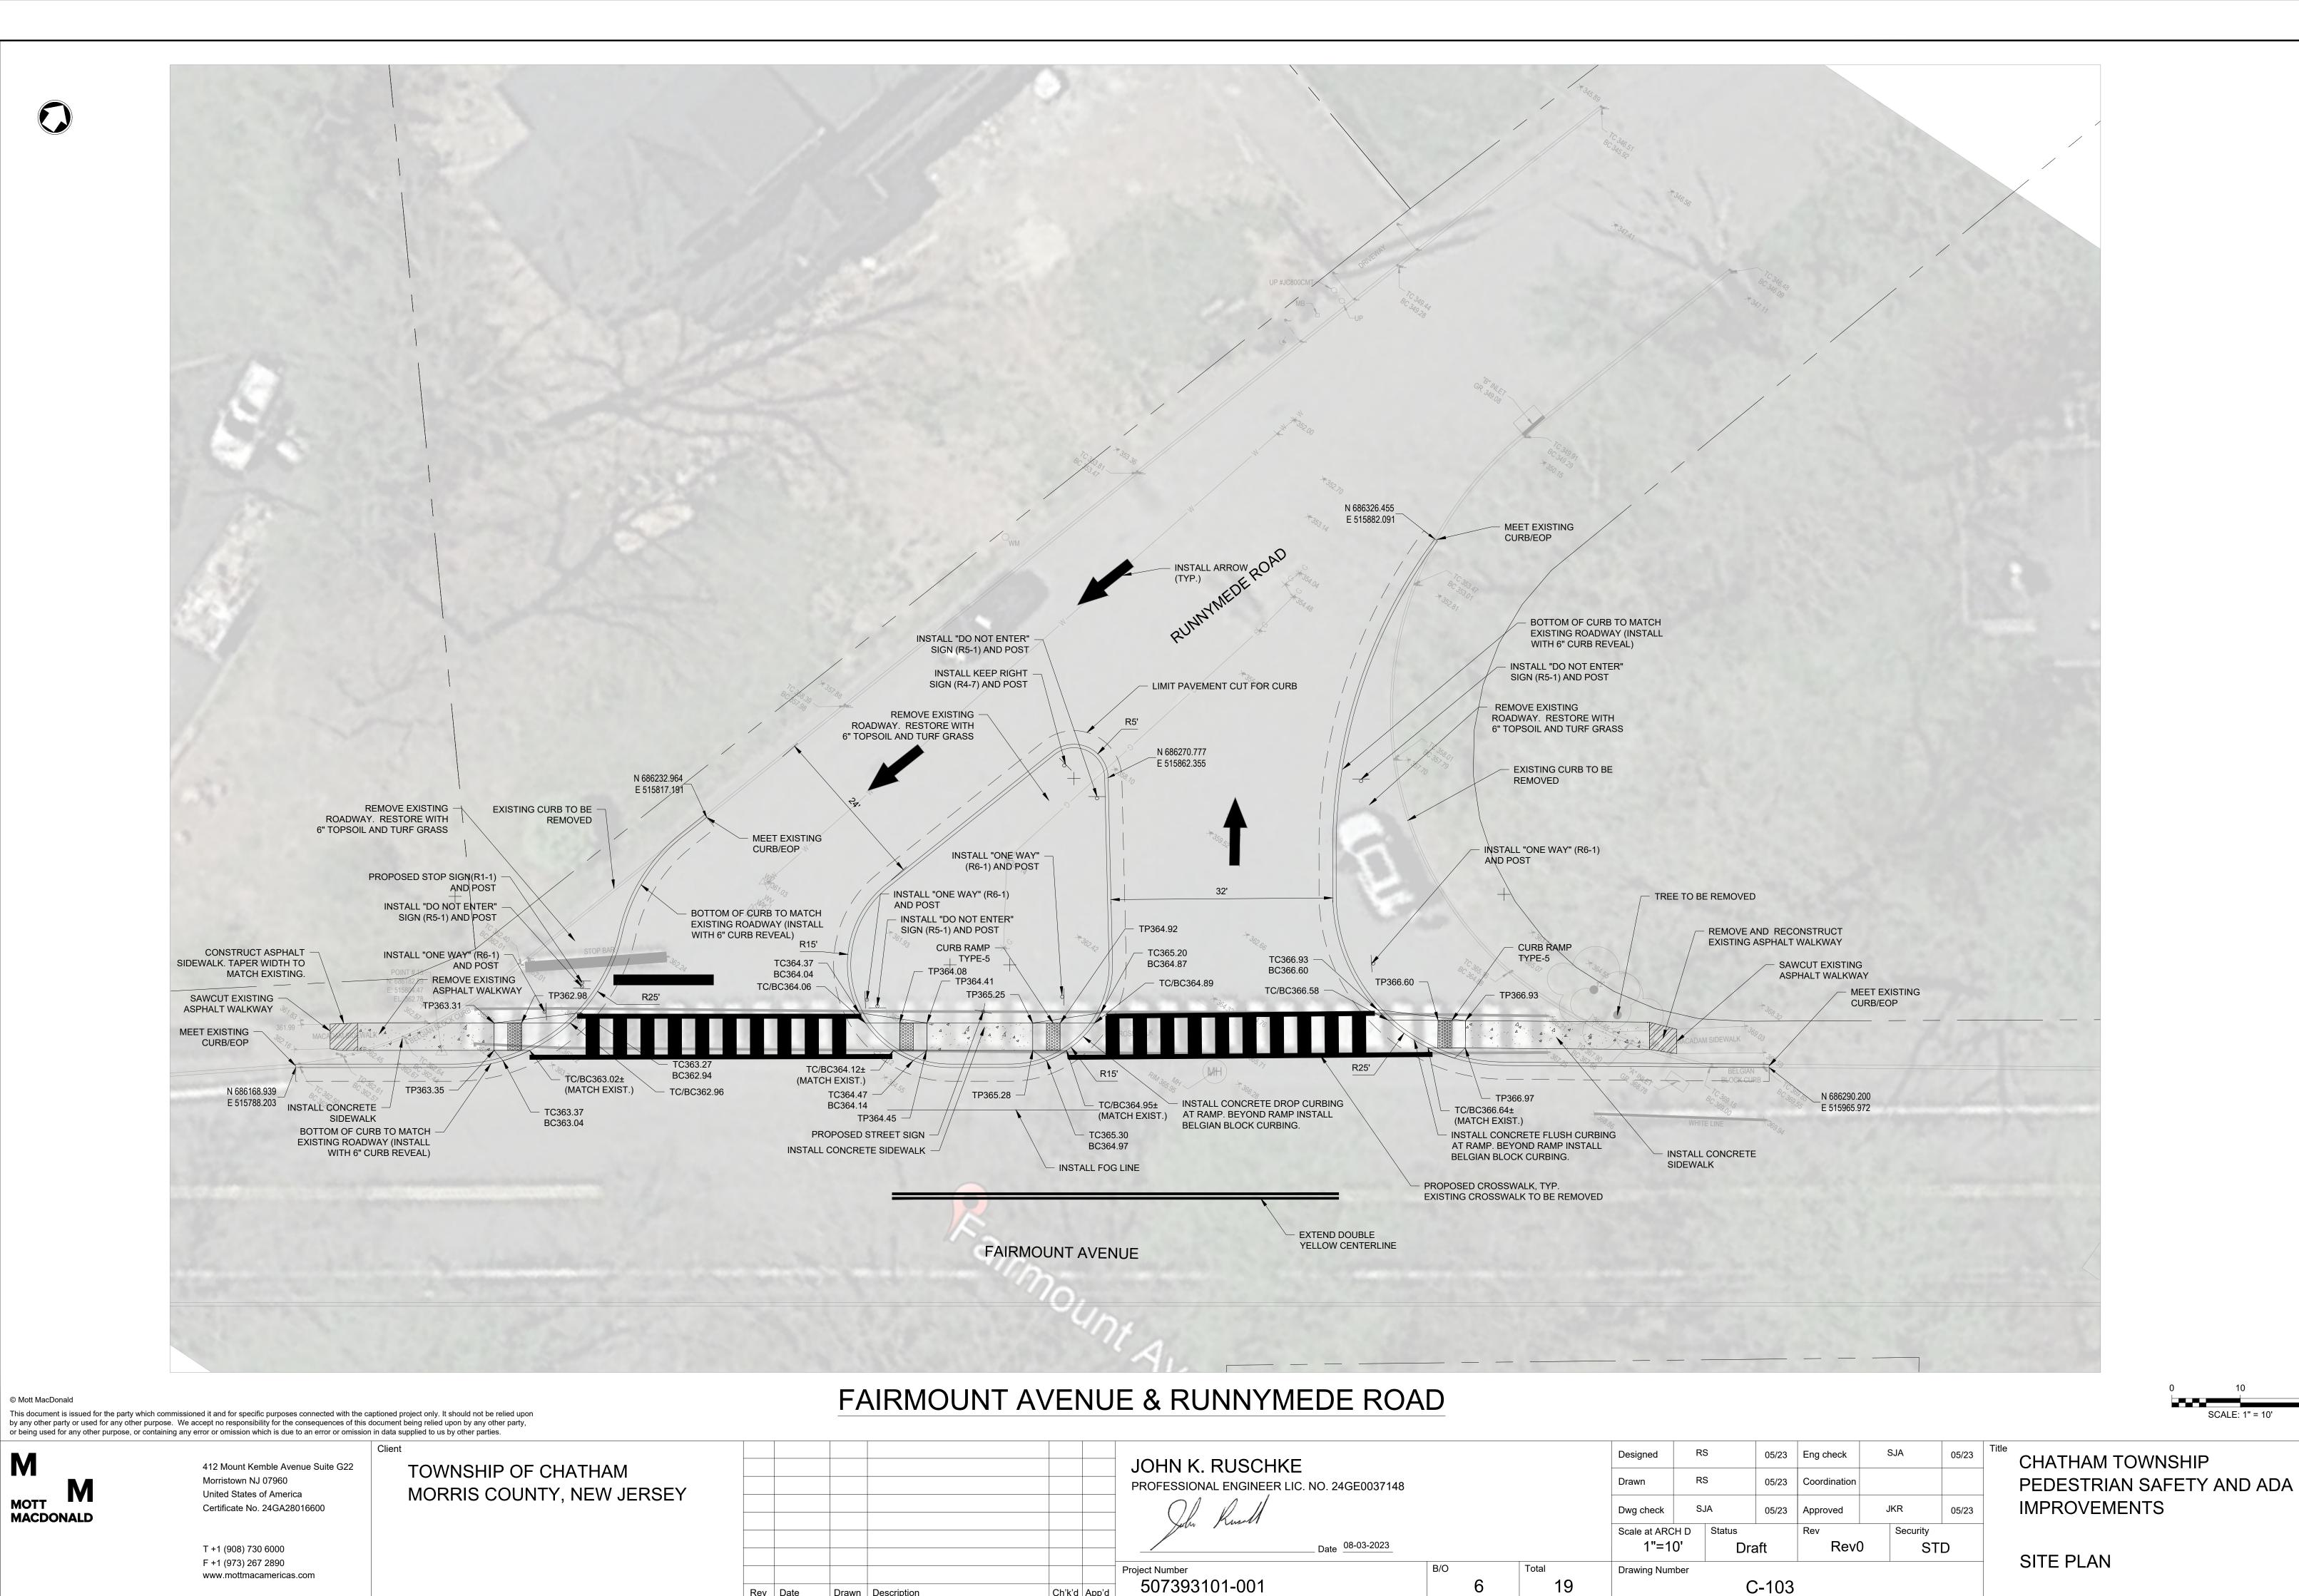
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Date 08-03-2023 Project Number

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CHATHAM TOWNSHIP
PEDESTRIAN SAFETY AND ADA
IMPROVEMENTS




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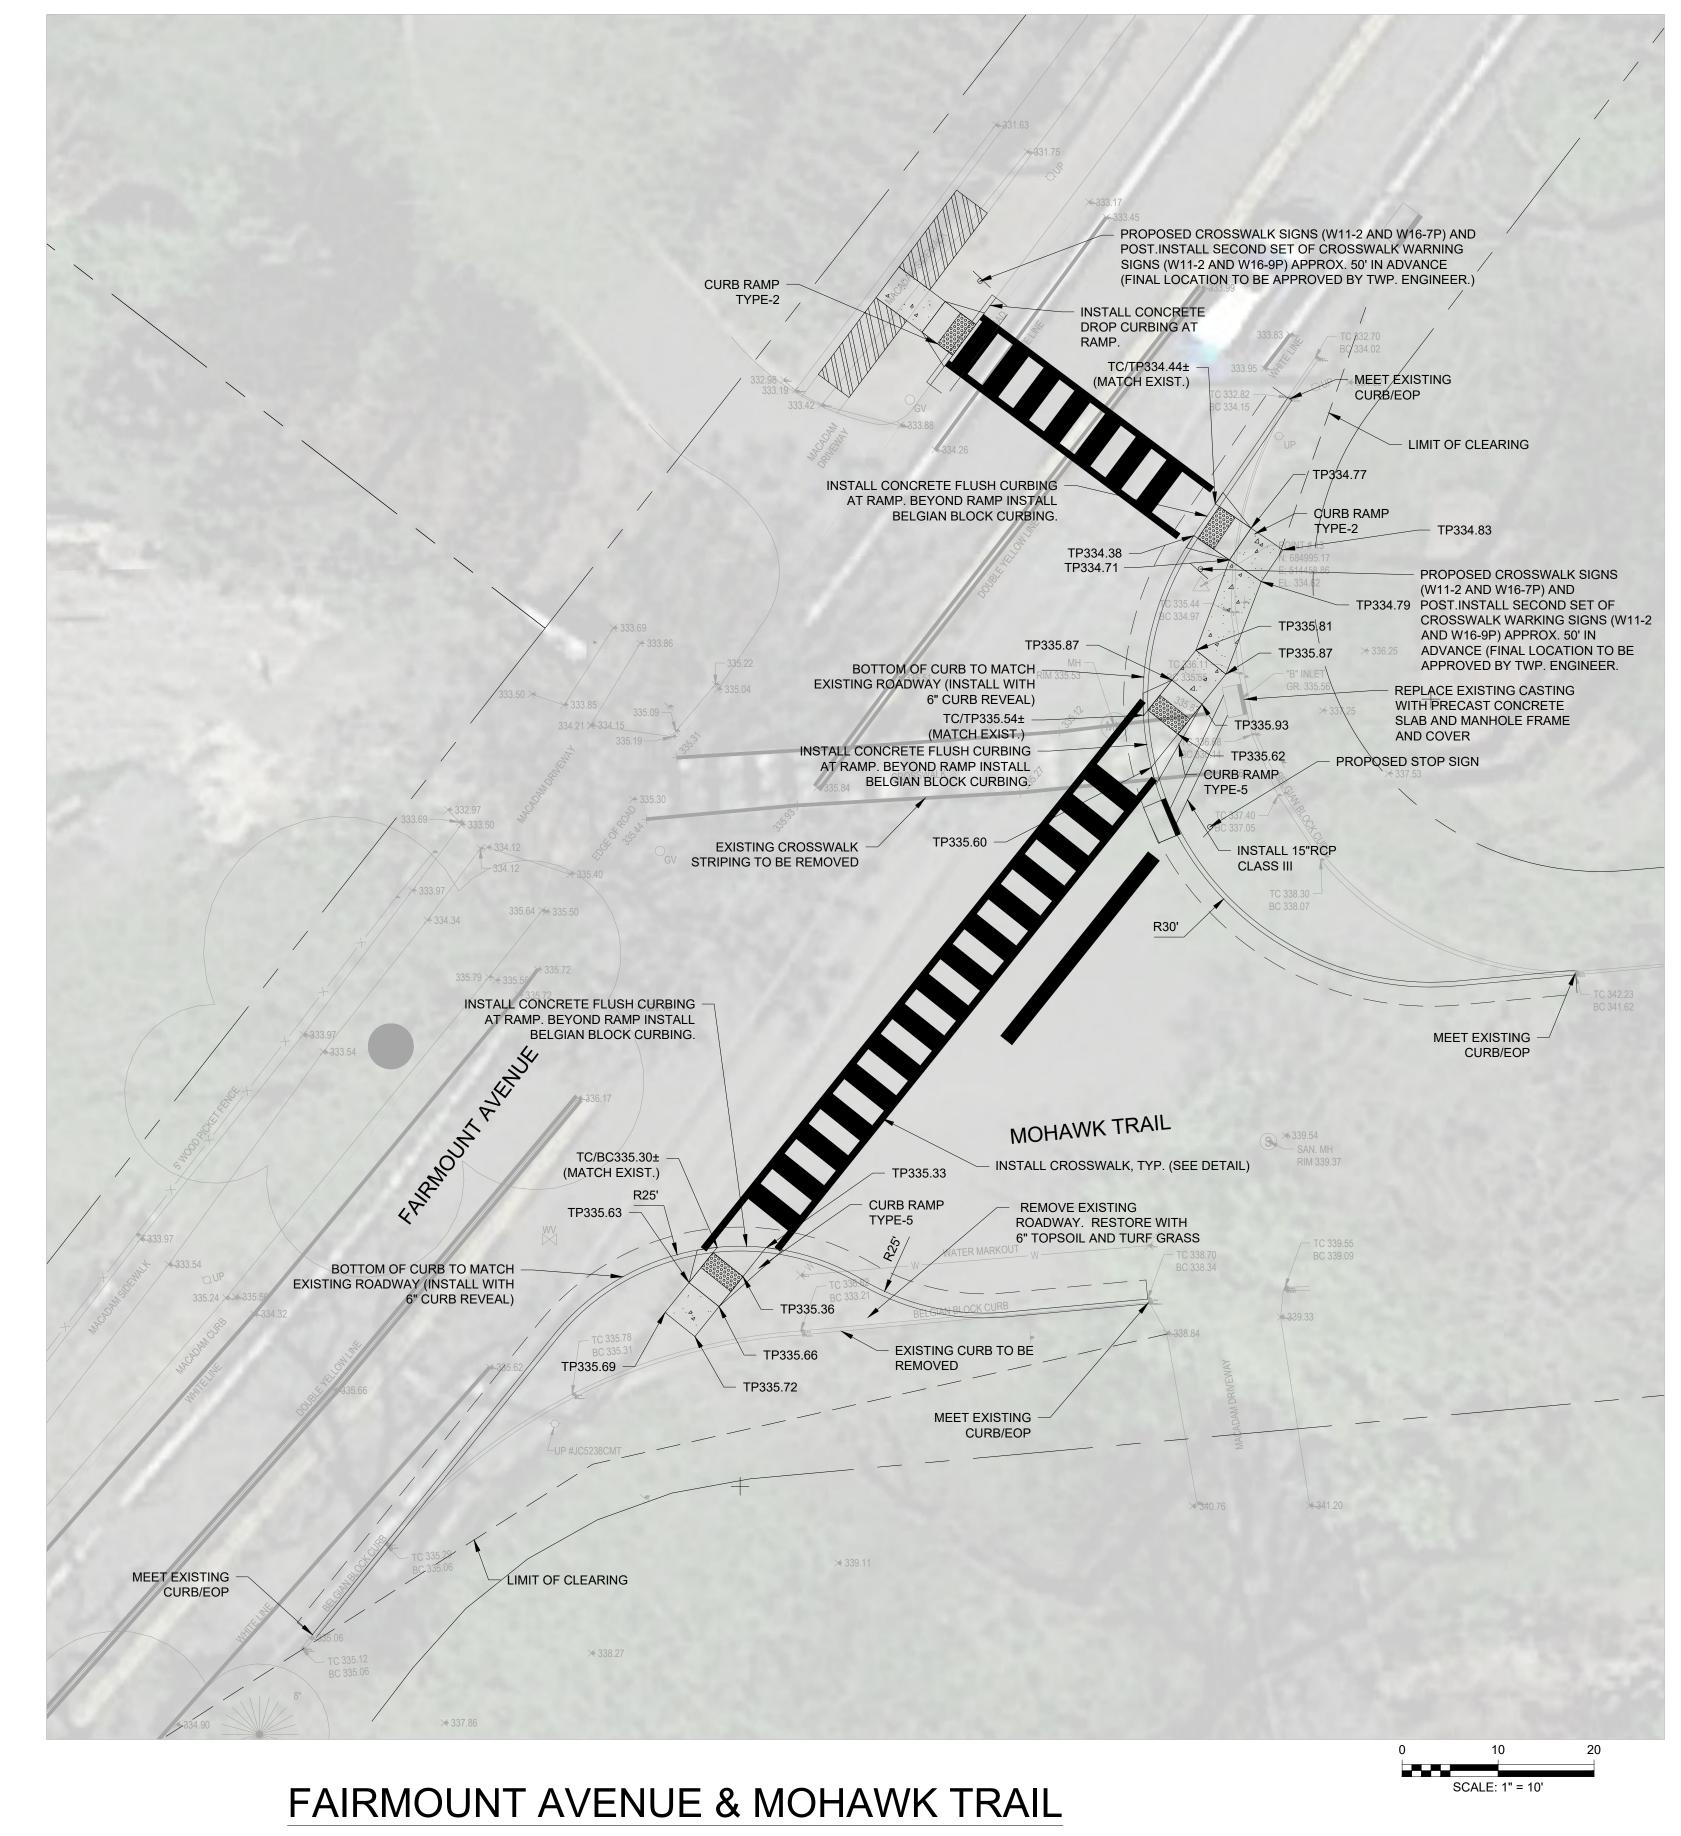
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FAIRMOUNT AVENUE & TANGLEWOOD LANE



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						Project Number
Rev	Date	Drawn	Description	Ch'k'd	App'd	507393101-001


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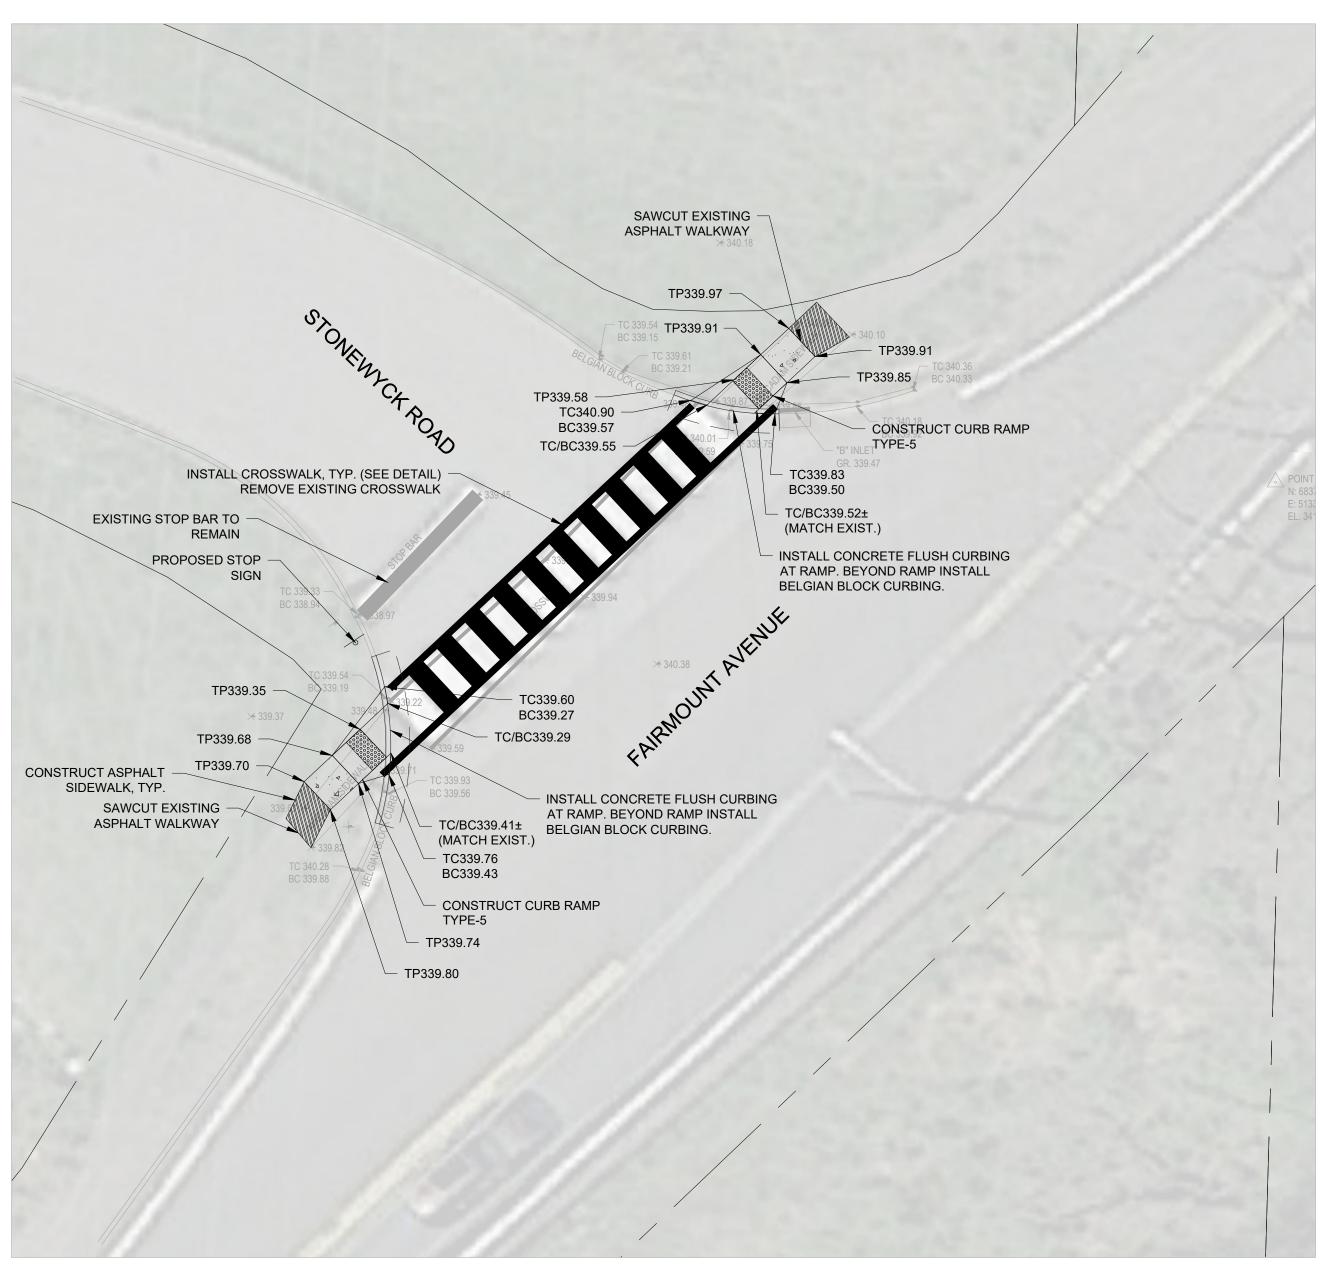
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CHATHAM TOWNSHIP PEDESTRIAN SAFETY AND ADA **IMPROVEMENTS**

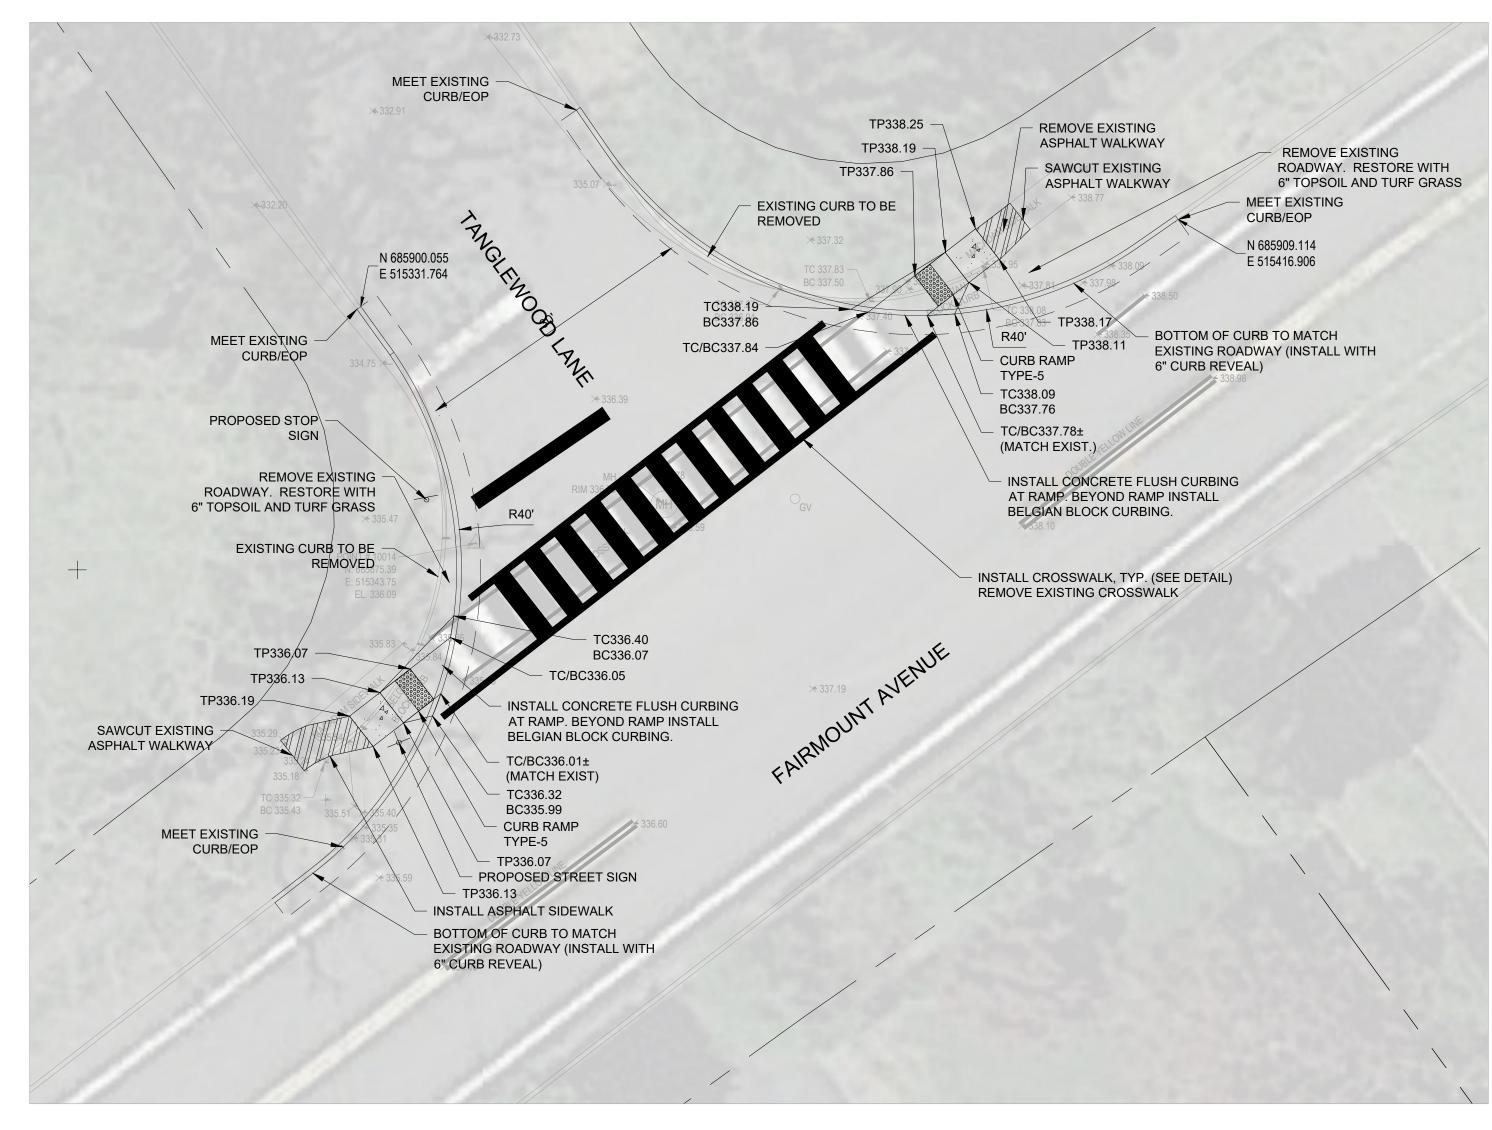

FAIRMOUNT AVENUE & BIRCH HILL DRIVE



FAIRMOUNT AVENUE & STONEWYCK ROAD

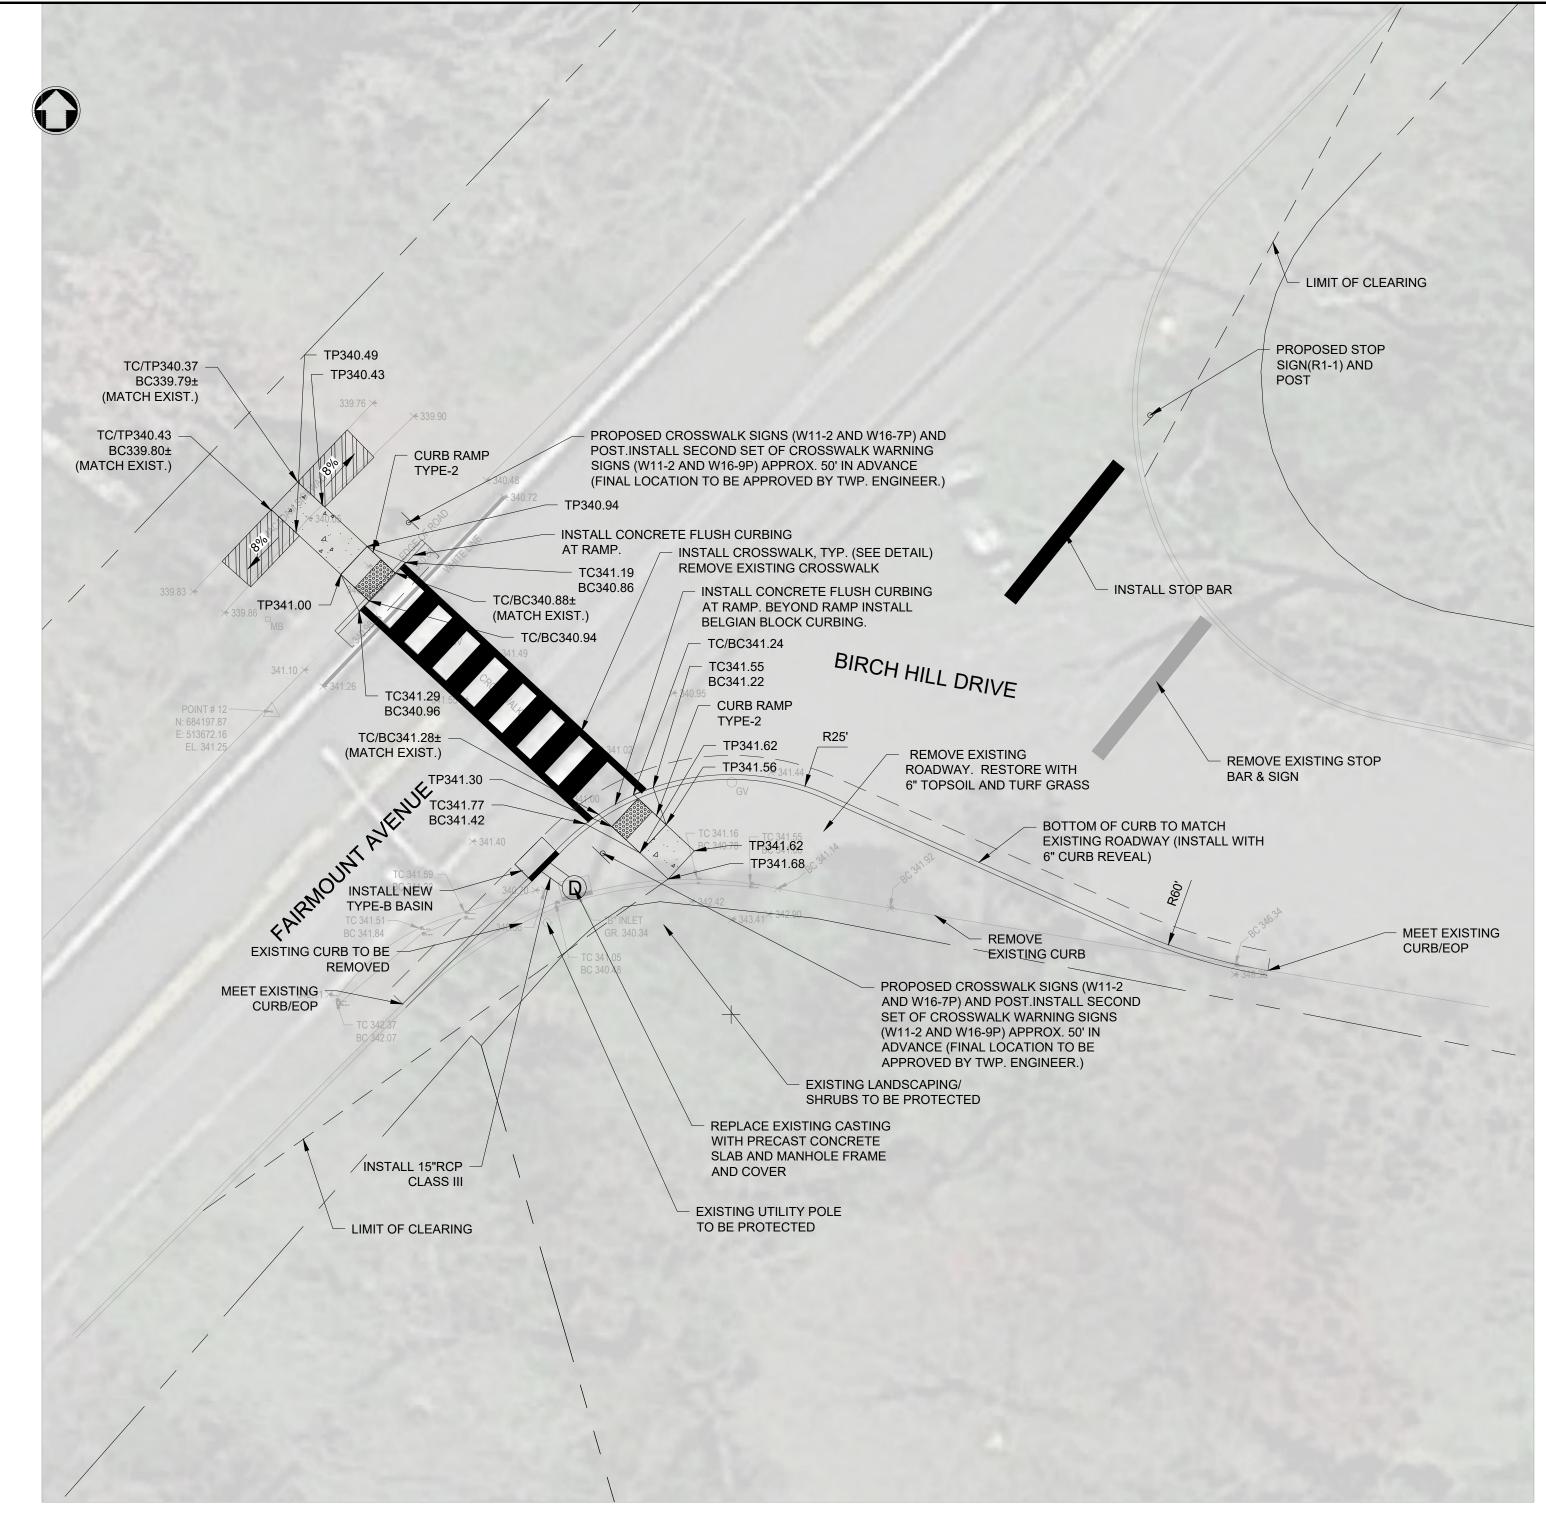0 10 20 SCALE: 1" = 10'

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TOWNSHIP OF CHATHAM
MORRIS COUNTY, NEW JERSEY

		JOHN K. RUSCHKE
		PROFESSIONAL ENGINEER LIC. NO. 24GE0037148
		John Kundt
		Date
		Date
		Project Number

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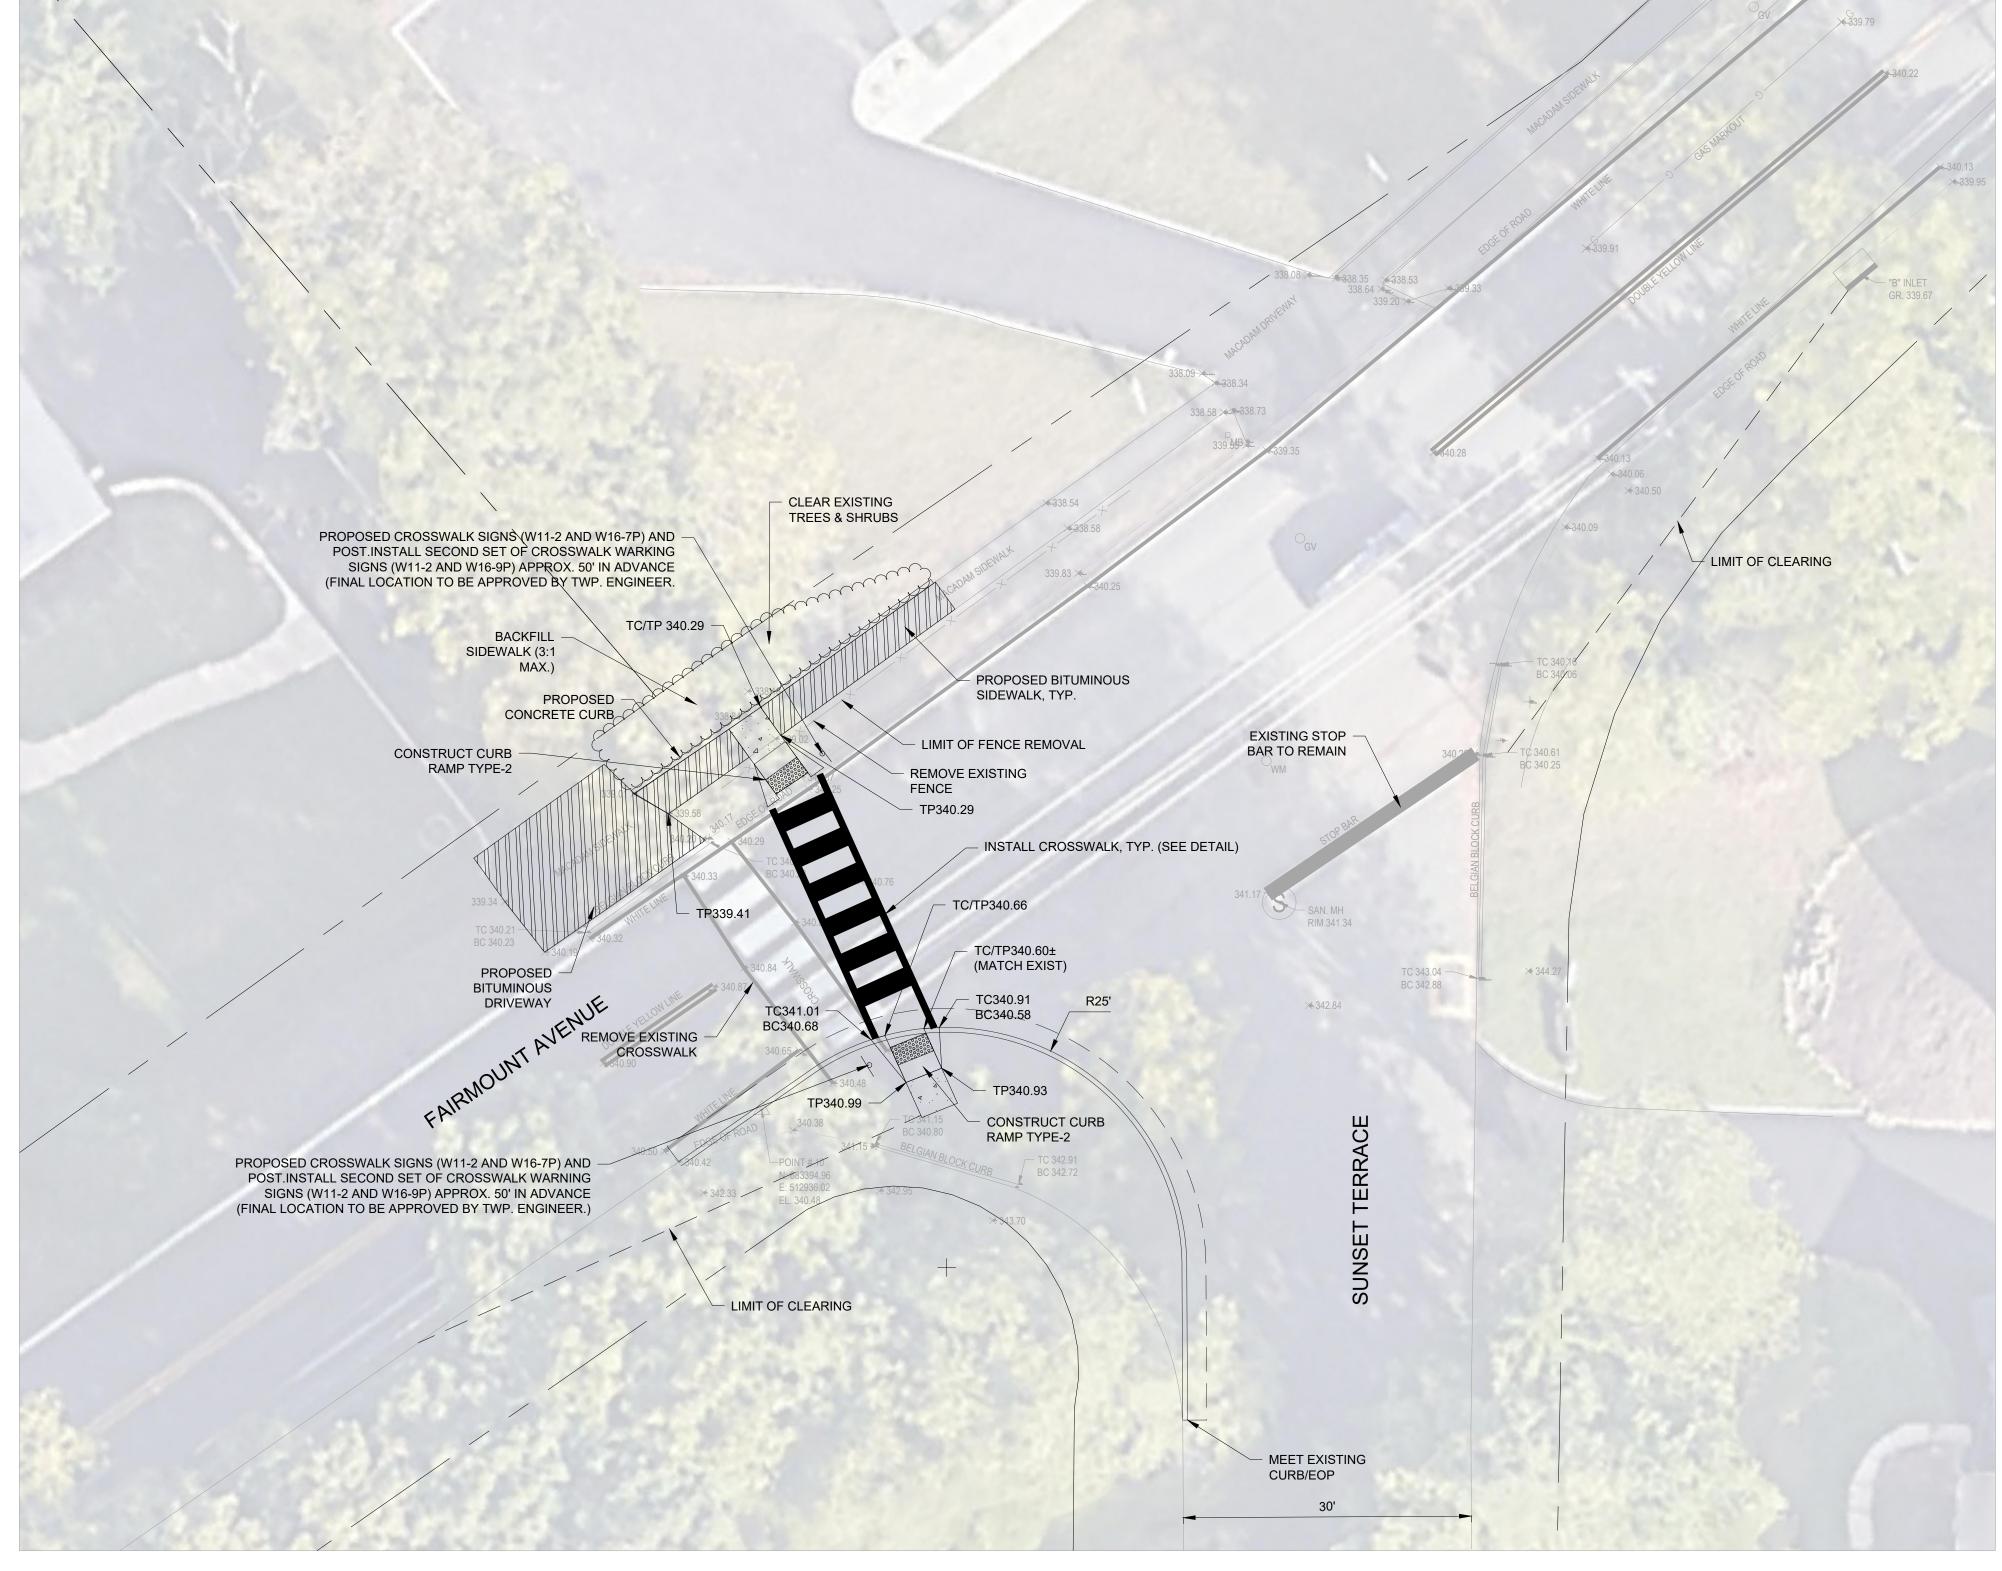
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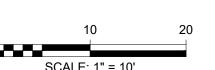
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CHATHAM TOWNSHIP
PEDESTRIAN SAFETY AND ADA
IMPROVEMENTS





FAIRMOUNT AVENUE & SUNSET TERRACE



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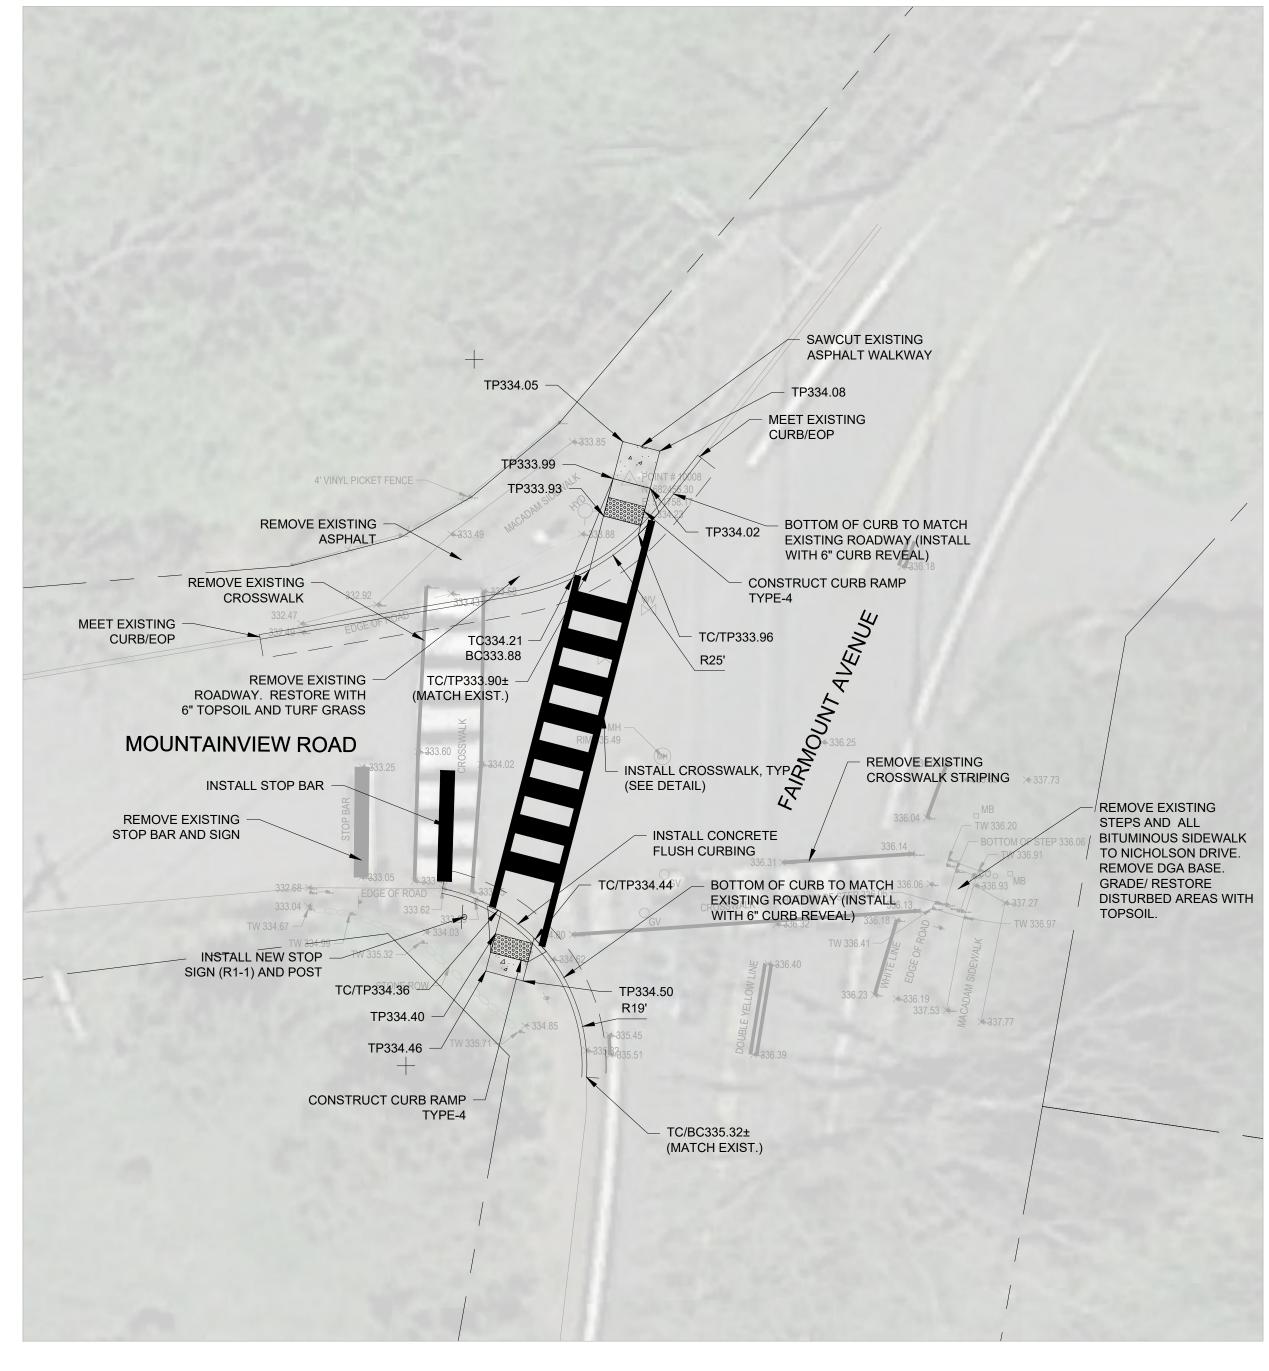
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PROFESSIONAL ENGINEER LIC. NO. 24GE0037148
John Russell
Date 08-03-2023
Project Number

507393101-001


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CHATHAM TOWNSHIP
PEDESTRIAN SAFETY AND ADA
IMPROVEMENTS






CURB RAMP DETAIL FAIRMOUNT AVENUE & MOUNTAINVIEW ROAD

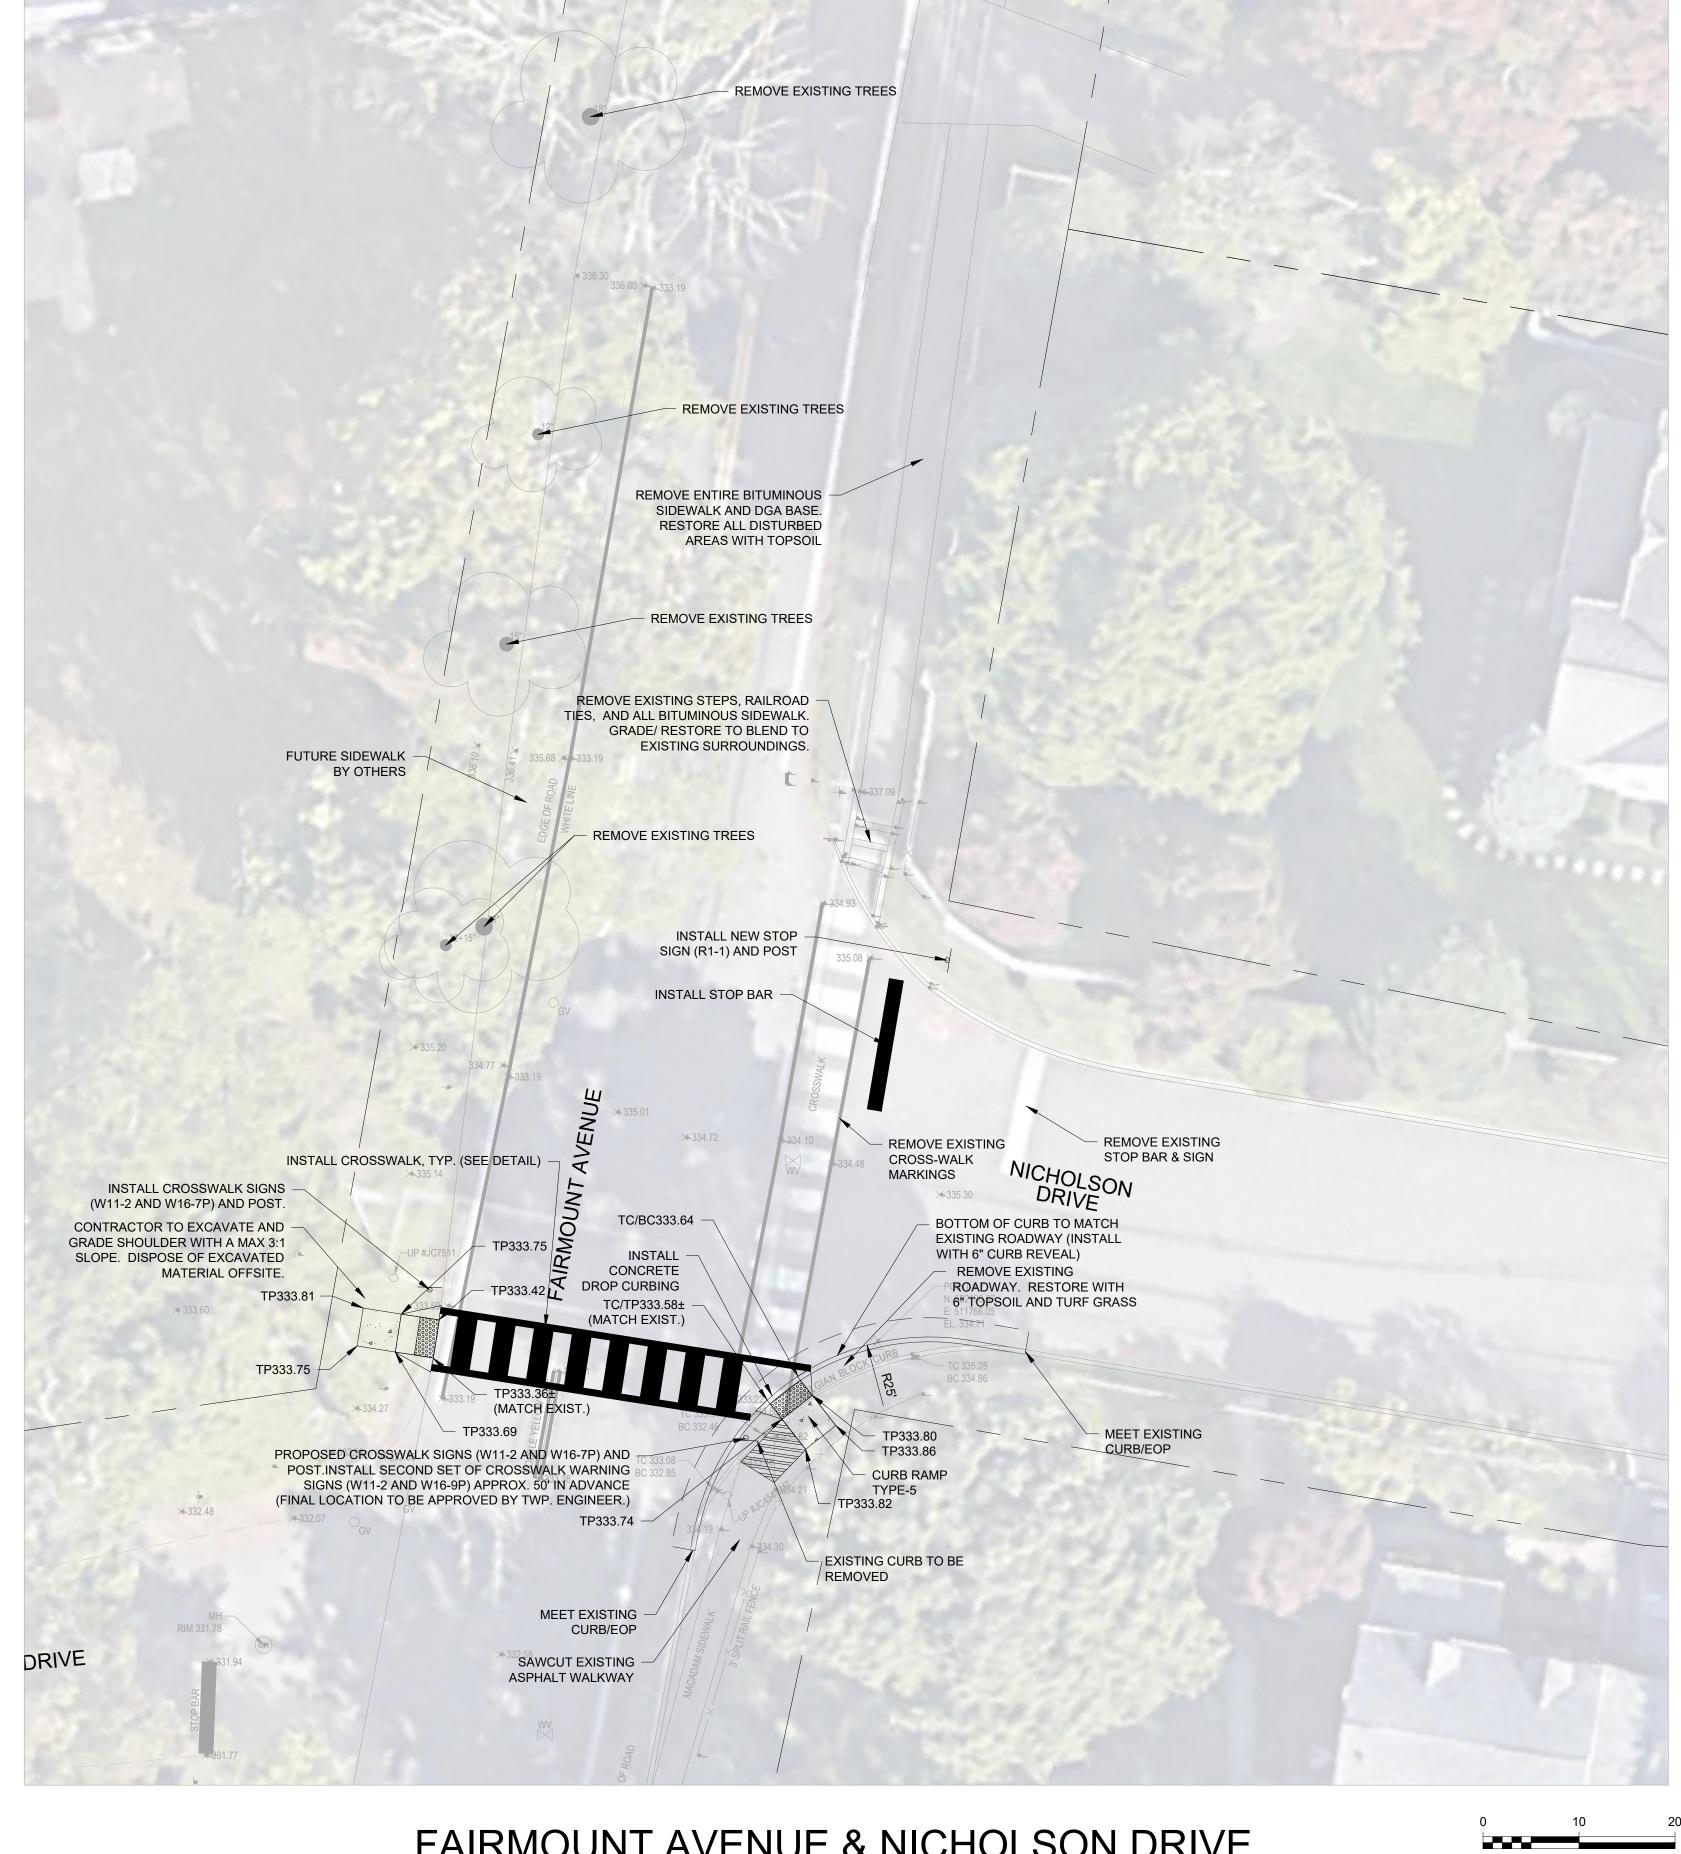

FAIRMOUNT AVENUE & NICHOLSON DRIVE

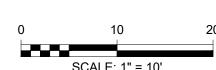

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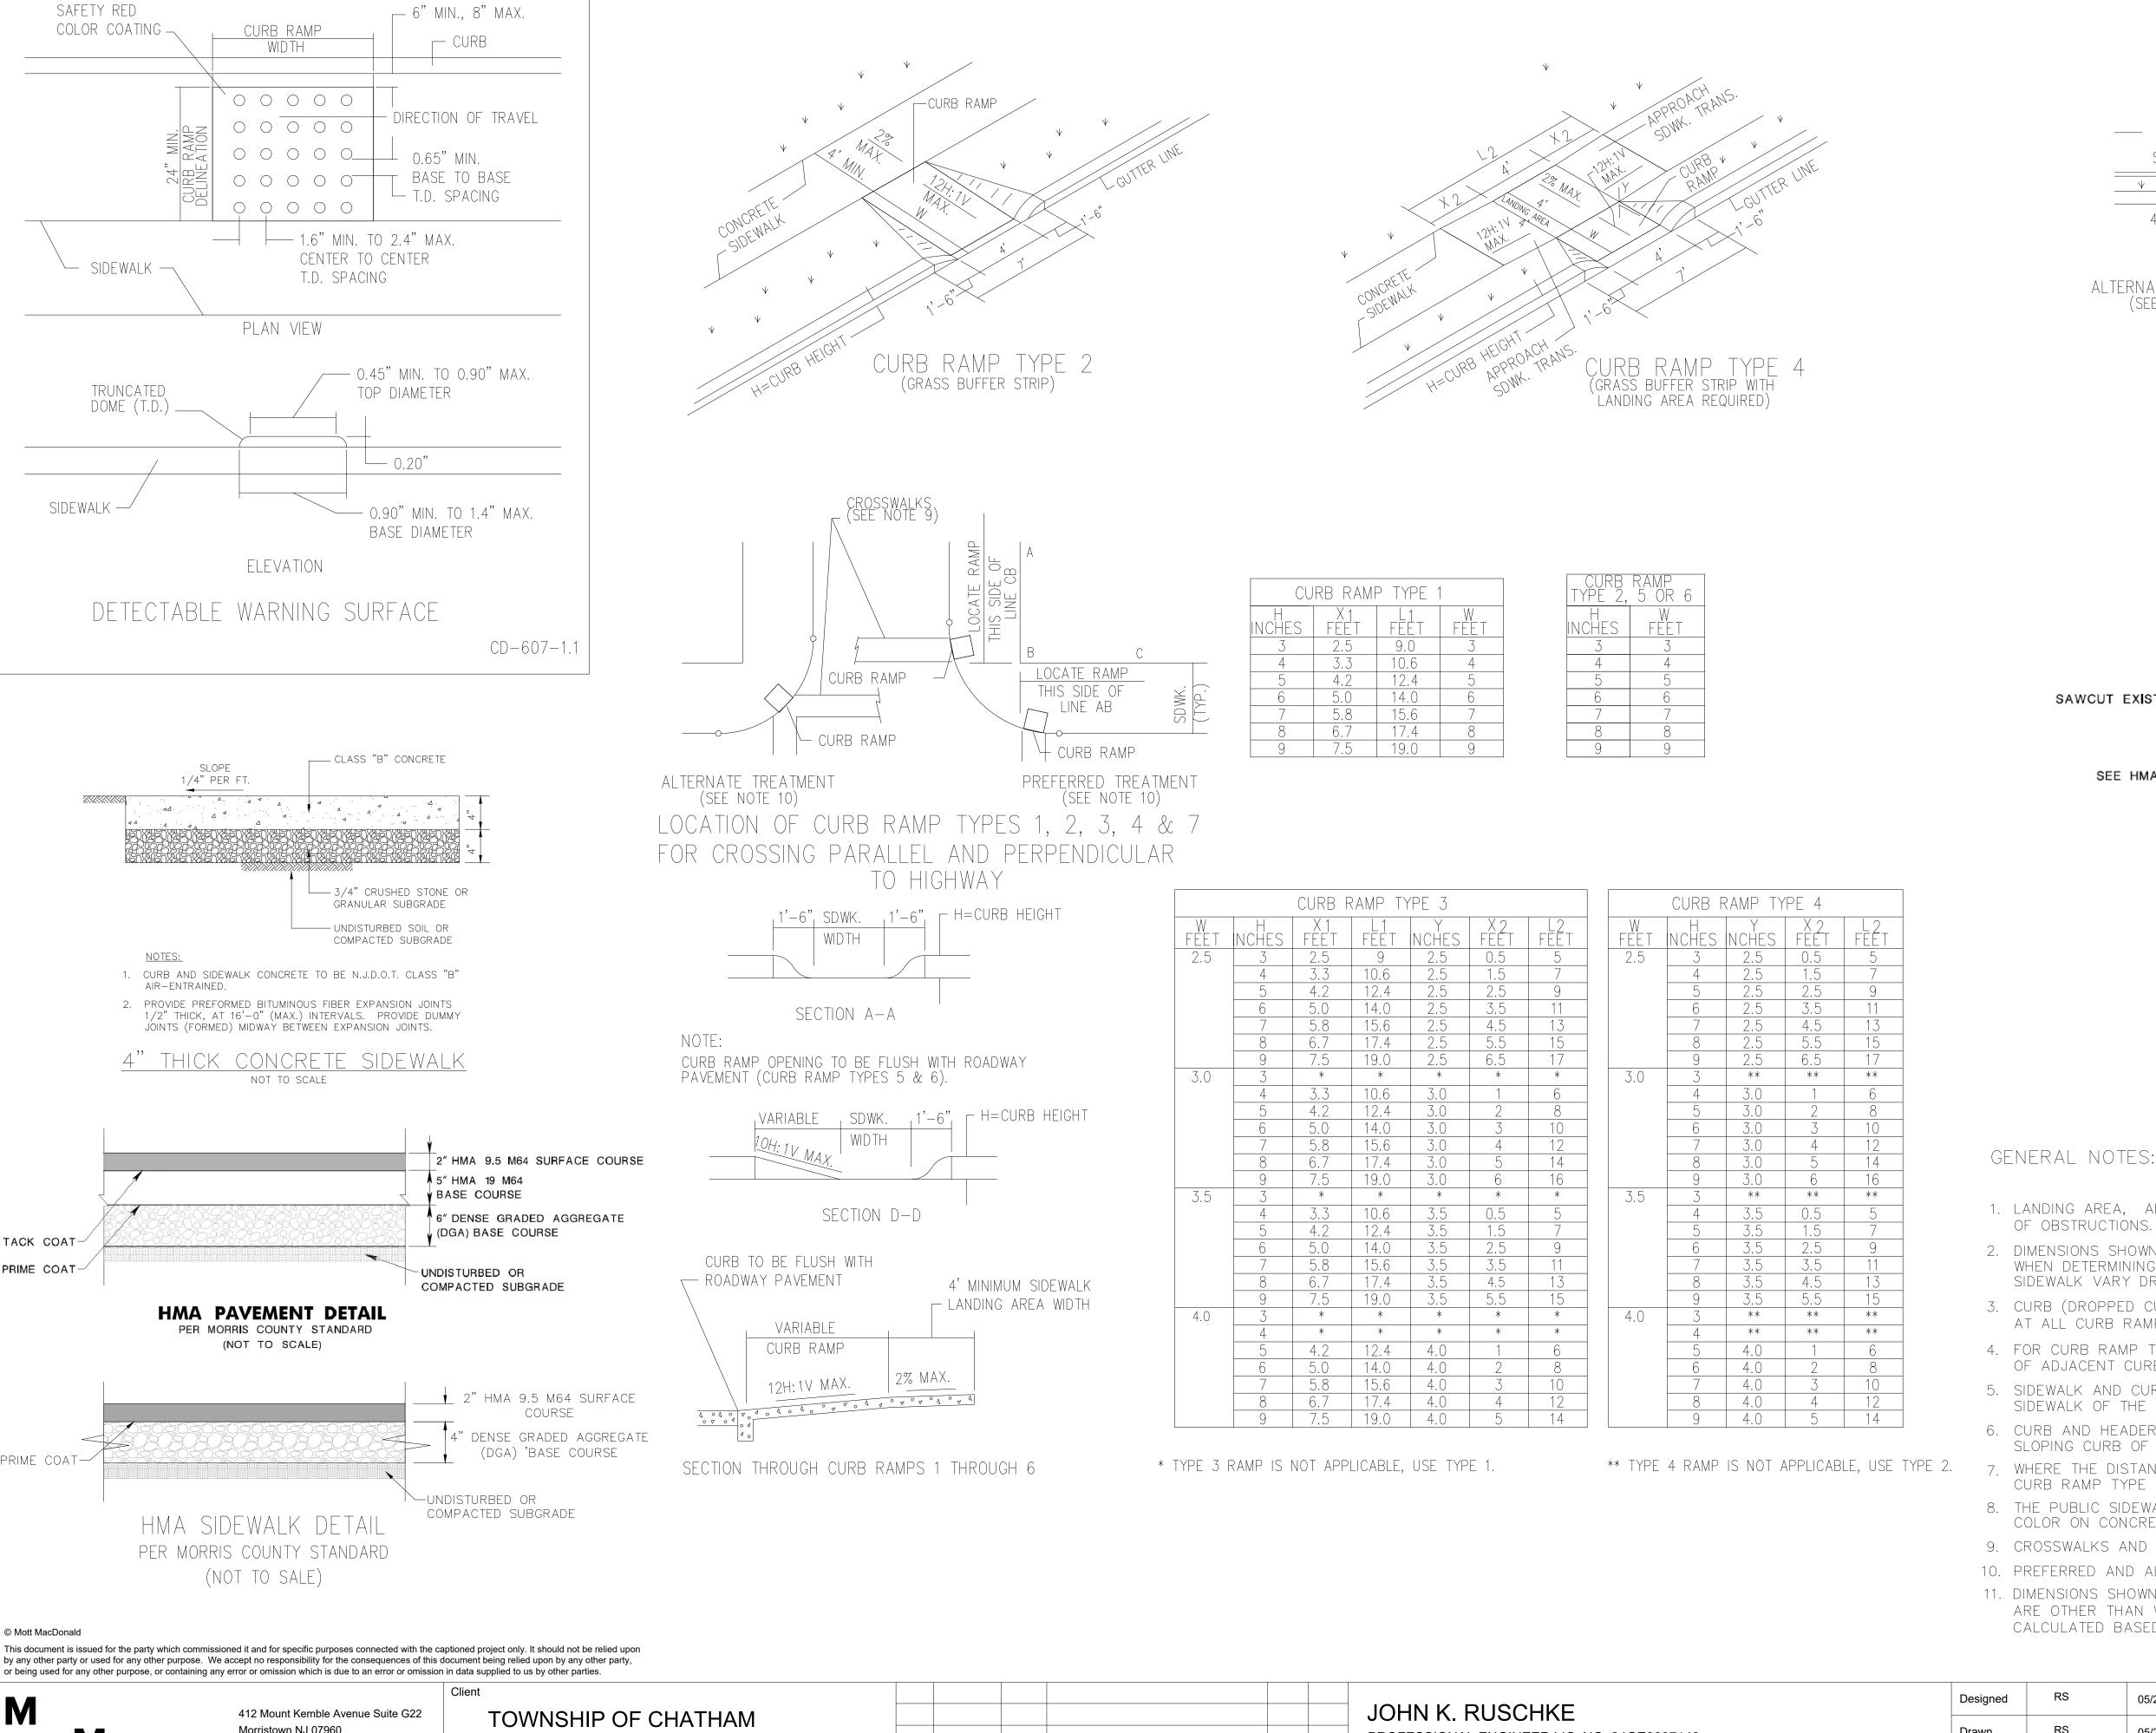
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						Project Number
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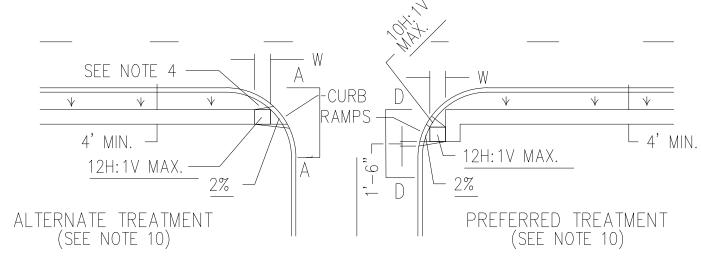
JOHN K. RUSCHKE PROFESSIONAL ENGINEER LIC. NO. 24GE0037148 Date 08-03-2023

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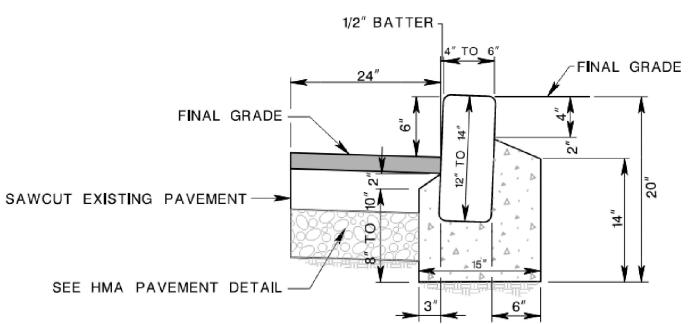
C-107

CHATHAM TOWNSHIP PEDESTRIAN SAFETY AND ADA **IMPROVEMENTS**





CURB RAMP TYPE 5 (CROSSING PARALLEL TO HIGHWAY ONLY)




- CONCRETE SHALL BE NJDOT CLASS "B" (AIR ENTRAINED)
- 2. FOUNDATION SHALL BE CONSTRUCTED THE ENTIRE LENGTH OF GRANITE BLOCK CURB.
- 3. BLOCK DIMENSIONS 4" X 7" X 12" WITH TOLERANCE OF 0.5" ON ALL DIMENSION

GRANITE BLOCK CURB PER MORRIS COUNTY STANDARD

(NOT TO SCALE)

GENERAL NOTES:

- 1. LANDING AREA, APPROACH SIDEWALK TRANSITIONS, AND CURB RAMP SHALL BE KEPT CLEAR
- 2. DIMENSIONS SHOWN IN TABLES ARE FOR RELATIVELY FLAT SIDEWALK AREAS. CARE SHOULD BE TAKEN WHEN DETERMINING CURB RAMP SIZE BASED ON CURB HEIGHT (H) WHERE ELEVATION OF CURB AND SIDEWALK VARY DRASTICALLY IN AREA OF PROPOSED CURB RAMP.
- 3. CURB (DROPPED CURB) GUTTERLINE TO BE FLUSH WITH ROADWAY PAVEMENT A MINIMUM OF 4 FEET AT ALL CURB RAMPS.
- 4. FOR CURB RAMP TYPES 5 AND 6, IF A GRASS BUFFER DOES NOT EXIST, SLOPE CURB TO EQUAL SLOPE OF ADJACENT CURB RAMP.
- 5. SIDEWALK AND CURB RAMP WITHIN AREA ENCLOSED BY HEAVY LINES TO BE PAID FOR AS CONCRETE SIDEWALK OF THE APPROPRIATE ADJACENT THICKNESS.
- 6. CURB AND HEADER WITHIN AREA ENCLOSED BY HEAVY LINES TO BE PAID FOR AS VERTICAL CURB OR SLOPING CURB OF THE APPROPRIATE ADJACENT SIZE AND KIND.
- 7. WHERE THE DISTANCE FROM THE GUTTER LINE TO THE OUTSIDE EDGE OF SIDEWALK IS 6 FEET OR LESS,
- CURB RAMP TYPE 7 SHOULD BE USED, INSTEAD OF CURB RAMP TYPE 1 THROUGH 4. 8. THE PUBLIC SIDEWALK CURB RAMP, DETECTABLE WARNING SURFACE (SHADED AREA) SHALL BE SAFETY RED COLOR ON CONCRETE OR 70% COLOR CONTRAST FOR OTHER SURFACE SUCH AS BRICK.
- 9. CROSSWALKS AND STOP LINES MAY BE MARKED OR UNMARKED, SEE PLANS.
- 10. PREFERRED AND ALTERNATE TREATMENTS SHOULD NOT BE INTERMIXED WITHIN THE SAME INTERSECTION.
- 11. DIMENSIONS SHOWN IN TABLES ARE FOR 3 INCH TO 9 INCH CURB HEIGHTS. WHERE THE CURB HEIGHTS ARE OTHER THAN WHAT IS PROVIDED IN THE TABLES, THE DIMENSIONS OF THE RAMPS WILL HAVE TO BE CALCULATED BASED ON CROSS SLOPES SHOWN.

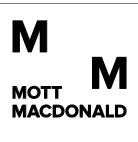


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MORRIS COUNTY, NEW JERSEY




PROFESSIONAL ENGINEER LIC. NO. 24GE0037148 Date <u>08-03-2023</u> **Project Number** 507393101-001

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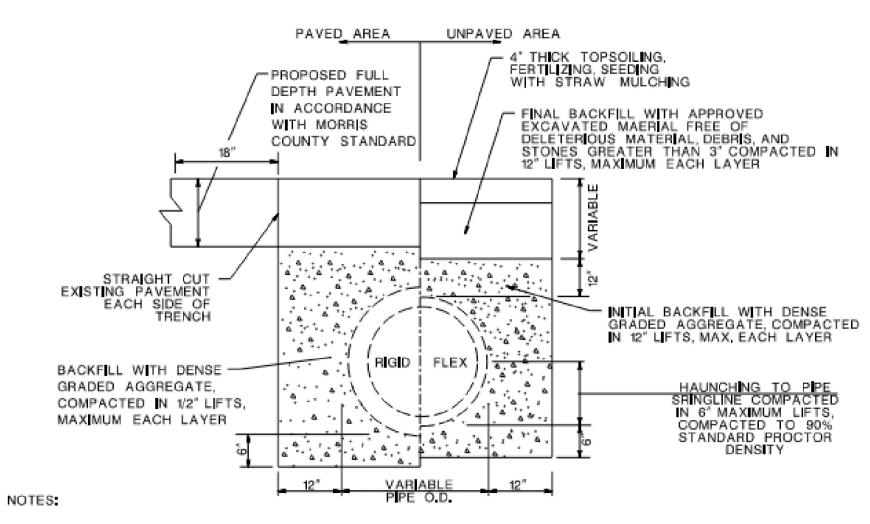
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CHATHAM TOWNSHIP PEDESTRIAN SAFETY AND ADA **IMPROVEMENTS**

CONSTRUCTION DETAILS

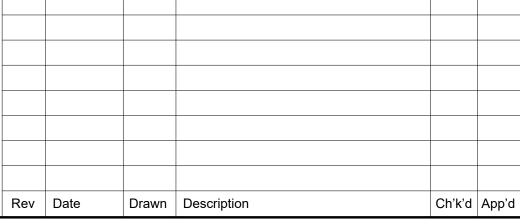

TYPICAL CROSSWALK DETAIL (NOT TO SCALE)

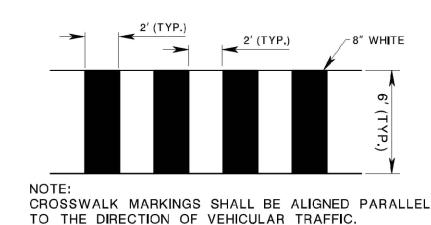


- 1. REINFORCED CONCRETE CULVERT PIPE, MINIMUM 15" DIAMETER, SHALL BE UTILIZED IN ALL COUNTY RIGHT OF-WAYS WHETHER PAVED OR UNPAVED.
- 2. CONTRACTOR SHALL HAND COMPACT DGA BENEATH THE HAUNCHES OF FLEXIBLE PIPE TO ENSURE INSTALLATION MEETS OR EXCEEDS MANUFACTURERS RECOMMENDATION.
- 3. IF NO OTHER CONTROLLING FACTORS EXIST, ALL CONCRETE PIPE SHALL BE INSTALLED IN ACCORDANCE WITH ACTIVE STANDARD ASTM C1479, ALL THERMOPLASTIC PIPE SHALL BE INSTALLED IN ACCORDANCE WITH ACTIVE STANDARD ASTM D2321.
- 4. SOIL IN THE OUTER BEDDING, HAUNCH, AND LOWER SIDE ZONES SHALL BE COMPACTED TO AT LEAST THE SAME COMPACTION AS THE MAJORITY OF SOIL IN THE OVERFILL ZONE, SOIL SHALL BE COMPACTED WITHIN 2% OF OPTIMUM
- 5. BACKFILLING WITH EXCAVATED MATERIAL SHALL NOT BE PERMITTED IN TRENCHES FOR STORM SEWERS AND ALL OTHER UTILITIES.
- TYPE OF SEEDING SHALL MEET THE MORRIS COUNTY SOIL CONSERVATION DISTRICT REQUIREMENTS.
- 7. SURFACE COURSE PAVEMENT SHALL BE PLACED IN TWO STAGES IN ACCORDANCE WITH THE FOLLOWING:

A. STAGE 1 - 2" HMA 9.5M64 SHALL BE COMPACTED FLUSH TO EXISTING PAVEMENT.

B. STAGE ■- AFTER 6 MONTHS, THE TRENCH WIDTH PLUS 36" SHALL BE MILLED 2" DEEP AND SHALL BE RESURFACED WITH 2" HMA 9.5M64 COMPACTED FLUSH TO EXISTING PAVEMENT.


STANDARD TRENCH


PER MORRIS COUNTY STANDARD NOT TO SCALE

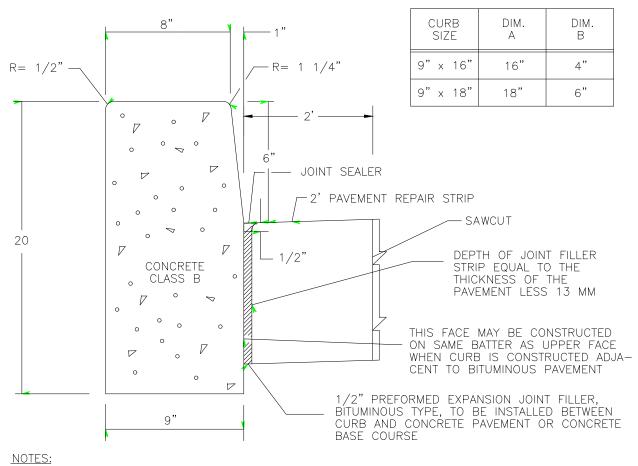

TRANSVERSE JOINTS 1/2" WIDE SHALL BE INSTALLED IN THE CURB 20 FT. APART AND SHALL BE FILLED WITH PREFORMED BITUMINOUS—IMPREGNATED FIBER JOINT FILLER RECESSED 1/4" IN FROM FRONT FACE AND TOP OF CURB. EXPANSION JOINTS THRU AND ADJACENT TO THE CURB SHALL BE INCLUDED IN THE UNIT PRICE BID FOR CURB.

9"X20" CONÇRETE VERTICAL CURB N.T.S.

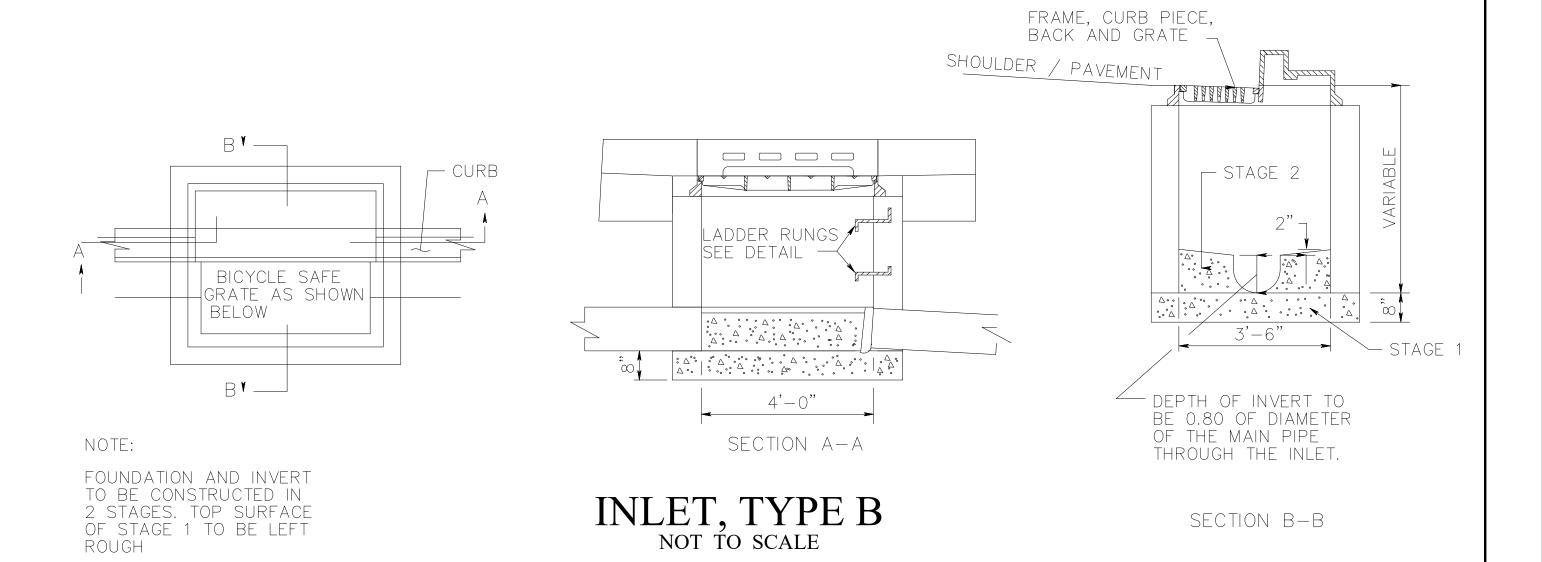

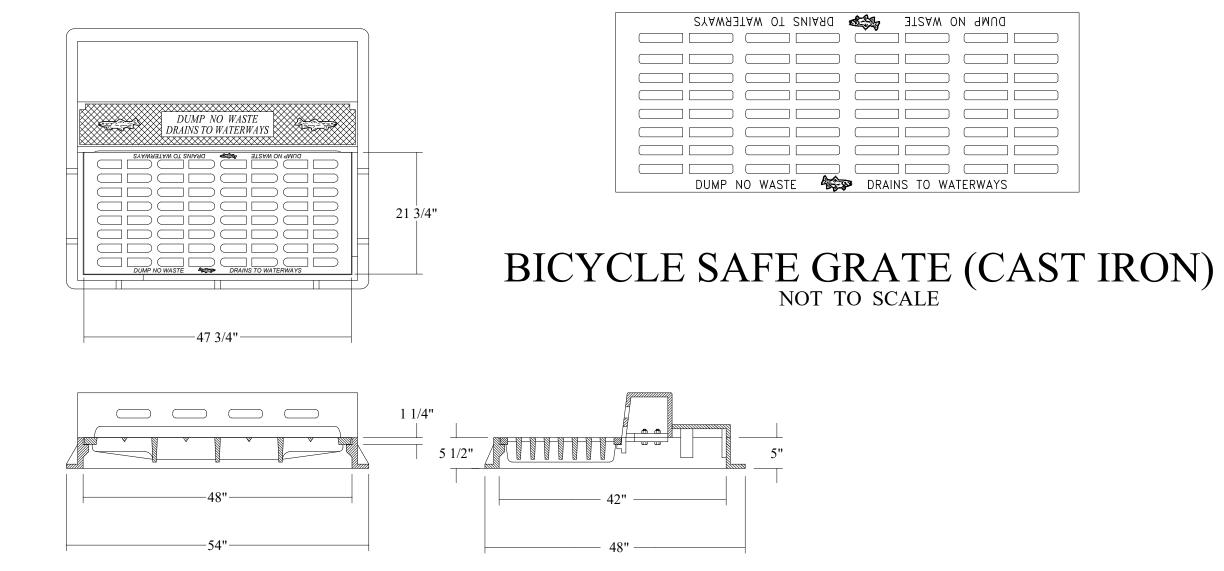

TYPE 'B' INLET CASTING NOT TO SCALE

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Project Number 507393101-001 Rev Date Drawn Description


JOHN K. RUSCHKE PROFESSIONAL ENGINEER LIC. NO. 24GE0037148 Date <u>08-03-2</u>023

SJA 05/23 Eng check Designed 05/23 Coordination Drawn JKR 05/23 05/23 Dwg check Approved Scale at ARCH D Status Security N.T.S. Rev0 STD Drawing Number


D-002

CHATHAM TOWNSHIP PEDESTRIAN SAFETY AND ADA **IMPROVEMENTS**

CONSTRUCTION DETAILS

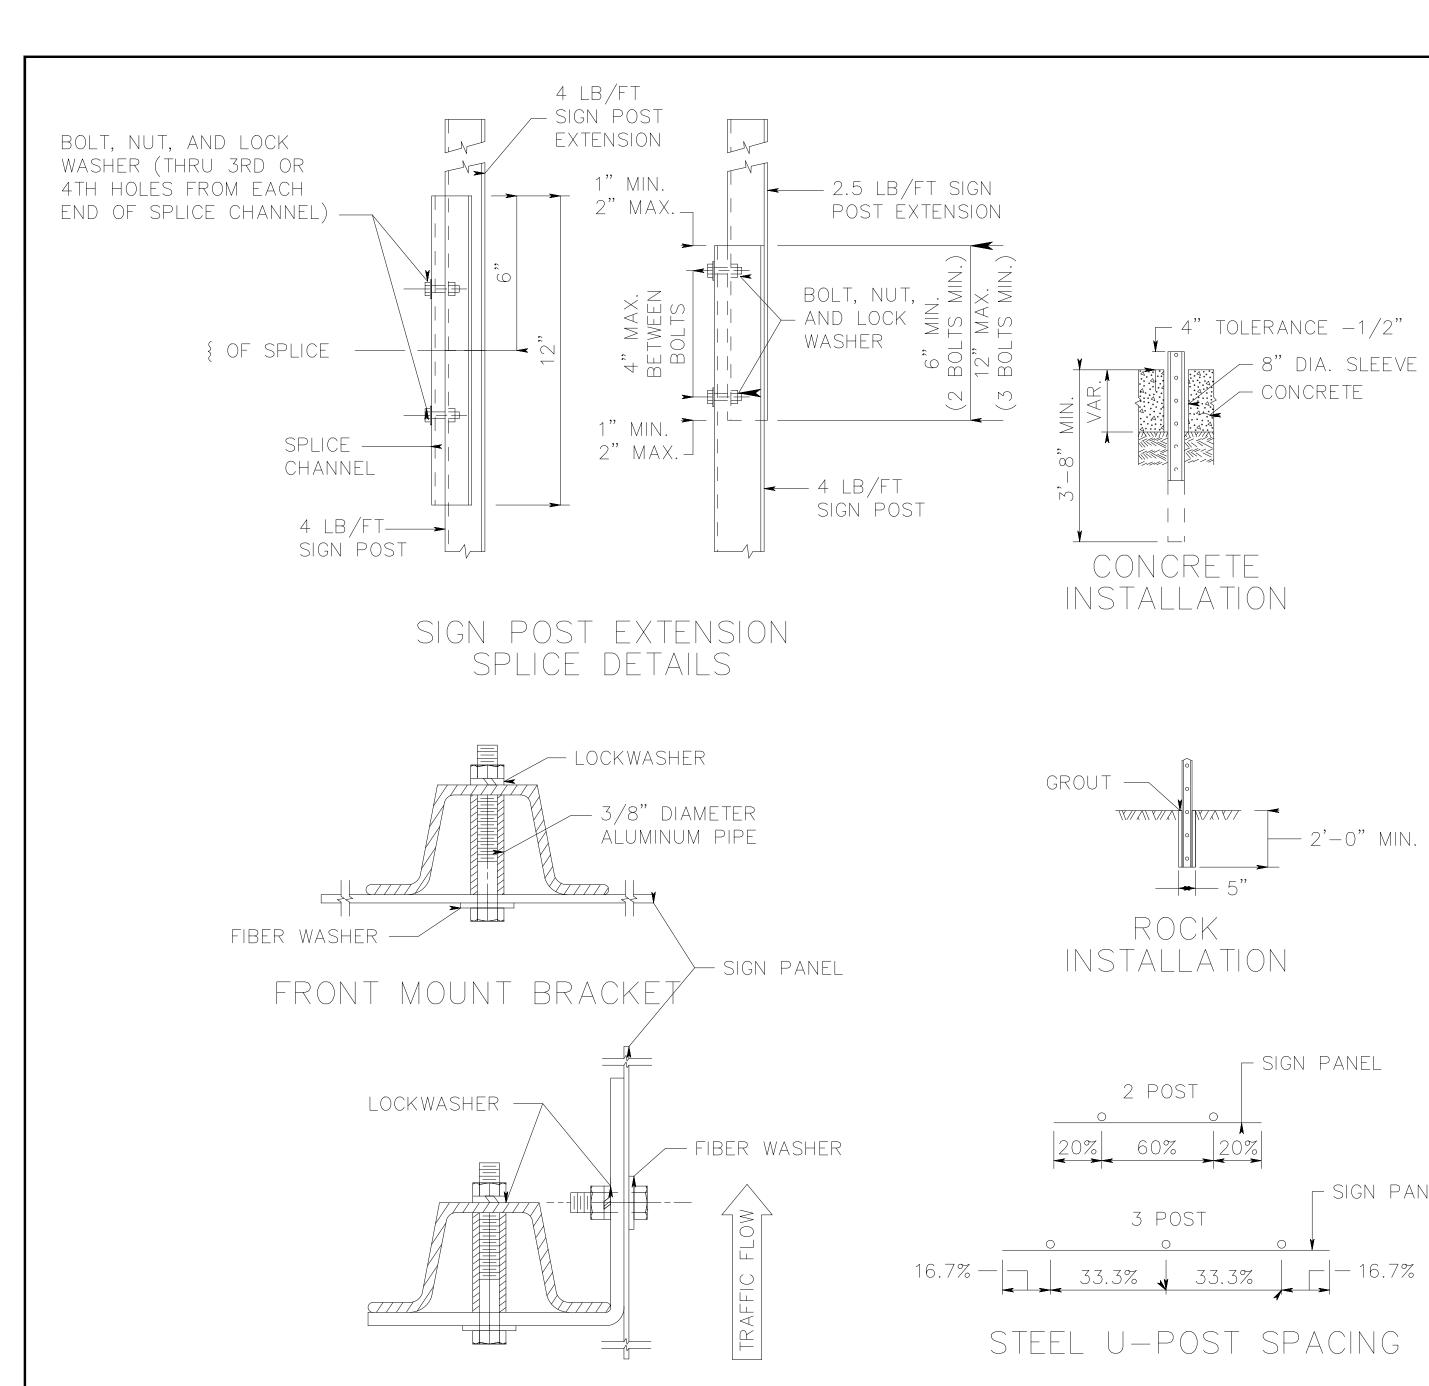

SIDE MOUNT BRACKET

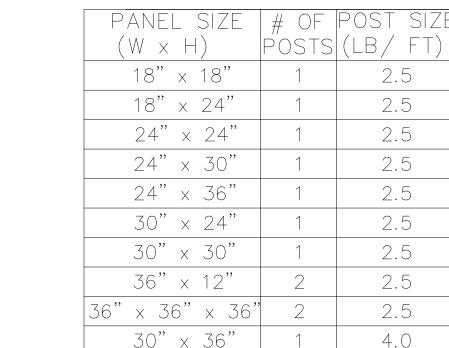

PANEL SIZE	# OF	POST SIZE	PANEL SIZE	# OF	POST S
$(W \times H)$	POSTS	(LB/ FT)	$(W \times H)$	POSTS	(LB/F
18" × 18"	1	2.5	36" × 36"	2	2.5
18" × 24"	1	2.5	36" × 48"	2	2.5
24" × 24"	1	2.5	45" × 36"	2	2.5
24" × 30"	1	2.5	48" × 24"	2	2.5
24" × 36"	1	2.5	48" × 36"	2	2.5
30" × 24"	1	2.5	48" × 48"	2	4.0
30" × 30"	1	2.5	48" × 64" × 64"	2	2.5
36" × 12"	2	2.5	60" x 36"	2	4.0
6" × 36" × 36"	2	2.5	48" × 60"	2	4.0
30" × 36"	1	4.0	60" x 30"	2	4.0

U-POST SELECTION TABLE

GENERAL NOTES:

- 1. ALL POSTS SHALL BE OF ADEQUATE LENGTH TO MEET THE REQUIREMENTS FOR ERECTION AS STATED IN THE CURRENT "MANUAL ON UNIFORM TRAFFIC CONTROL DEVICES FOR STREETS AND HIGHWAYS" AND AS INDICATED BELOW.
- 2. ALL SMALL SIGN SUPPORTS SHALL BE OF THE BREAKAWAY TYPE WITH EXCEPTION OF THOSE INSTALLED BEHIND GUIDE RAIL OR OTHER ROADSIDE BARRIER.
- 3. ALL STEEL POSTS AND BRACKETS SHALL BE CUT, BENT, AND HOLES PUNCHED AND DRILLED BEFORE GALVANIZING. GALVINIZING SHALL BE IN CONFORMANCE WITH ASTM A123.
- 4. ALL STEEL U-POST SIGN SUPPORTS MUST BE INSTALLED FACING THE PREDOMINANT TRAFFIC FLOW. A MOUNTING BRACKET SHOULD BE USED ON SIDE MOUNTED SIGNS SUCH AS "ONE WAY" SIGNS INSTALLED IN MEDIANS.
- 5. SIGN PANEL SIZES SHALL DETERMINE POST TYPE AND NUMBER AS SHOWN ON THIS DETAIL.
- 6. BOLTS SHALL NOT PROTRUDE MORE THAN 3/4" BEYOND THE NUT WHEN TIGHT, BUT SHALL ENGAGE ALL THREADS IN THE NUT.
- 7. WHEN SIGNS ARE INSTALLED ON SLOPES 10H:1V OR FLATTER, THE MINIMUM VERTICAL CLEARANCE REQUIREMENTS FOR SIGNS ARE:

FOR SINGLE POST INSTALLATIONS — THE MINIMUM DISTANCE BETWEEN THE EDGE OF THE PAVEMENT AND THE BOTTOM OF ANY PANEL MUST BE 7 FEET, AND THE MINIMUM DISTANCE FROM EDGE OF PAVEMENT TO THE TOP OF ANY SIGN PANEL MUST BE 9 FEET.

FOR MULTI-POST INSTALLATIONS - THE MINIMUM DISTANCE BETWEEN THE EDGE OF PAVEMENT AND THE BOTTOM OF A MAJOR SIGN PANEL MUST BE 7 FEET.

SECONDARY SIGN PANELS (LAND SERVICE HIGHWAYS) — THE MINIMUM DISTANCE BETWEEN THE EDGE OF PAVEMENT AND THE BOTTOM OF A SECONDARY SIGN PANEL IS 6 FEET.


SECONDARY SIGN PANELS (INTERSTATE AND FREEWAYS) — THE BOTTOM OF THE MAJOR SIGN SHALL BE A MINIMUM OF 8 FEET AND THE SECONDARY SIGN PANEL A MINIMUM OF 5 FEET ABOVE THE EDGE OF PAVEMENT.

WHERE GRADING OF 10H: 1V OR FLATTER CANNOT BE OBTAINED, OR WHERE CURB OR BERM IS GREATER THAN 4 INCHES, THE MINIMUM VERTICAL CLEARANCE WILL BE MEASURED FROM THE GROUND LINE TO THE BOTTOM OF THE SIGN.

- 8. PERMANENT SIGN SUPPORTS SHOULD NOT BE INSTALLED ON SLOPES GREATER THAN 10H:1V, EXCEPT WHERE GRADING OF 10H:1V CANNOT BE OBTAINED OR THE SIGN SUPPORTS WILL BE BEHIND A TRAFFIC BARRIER. THE SLOPE SHALL EXTEND A MINIMUM OF 3 FEET BEYOND THE OUTSIDE EDGE OF SIGN (SEE GRADING DETAIL FOR SLOPE TREATMENT).
- 9. EXTRUDED ALUMINUM SIGN PANELS ARE NOT PERMITTED FOR USE WITH STEEL U-POST SIGN SUPPORTS.
- 10. STEEL U-POST SIGN SUPPORTS SHALL NOT BE PLACED IN FRONT OF GUIDE RAIL AND THE POSTS MUST NOT STRADDLE GUIDE RAIL.
- 11. TO EXTEND THE HEIGHT OF A SIGN POST, A MAXIMUM OF ONE SPLICE MAY BE MADE AND MUST BE A MINIMUM OF 9 FEET FROM THE GROUNDLINE TO CENTER LINE OF SPLICE.

STEEL U-POST SIGN SUPPORTS

N.T.S.

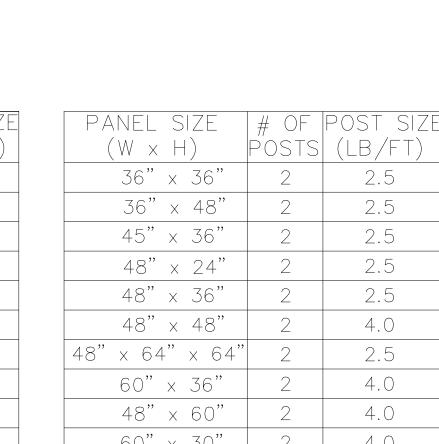

-4" TOLERANCE -1/2"

CONCRETE

CONCRETE

ROCK

2 POST

3 POST

8" DIA. SLEEVE

- 2'-0" MIN.

- SIGN PANEL

- SIGN PANEL

BREAKAWAY SIGN SUPPORT

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3/8" DIA. HOLE-

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DETAIL OF BRACKET

SIDE MOUNTED SIGNS

TOWNSHIP OF CHATHAM MORRIS COUNTY, NEW JERSEY



JOHN K. RUSCHKE PROFESSIONAL ENGINEER LIC. NO. 24GE0037148

BREAKAWAY

- BREAKAWAY

STEEL U-POST

30" × 30"

OR

SMALLER

30" × 30" OR

SMALLER

STEEL U-POST

- BREAKAWAY

24" × 24"

SHIELD

STEEL U-POST

Date <u>08-03-2023</u> **Project Number**

13

19


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507393101-001

05/23 Eng check Designed 05/23 Coordination Drawn 05/23 05/23 Dwg check Approved Scale at ARCH D Status N.T.S. Rev0 STD Drawing Number

CHATHAM TOWNSHIP PEDESTRIAN SAFETY AND ADA **IMPROVEMENTS**


CONSTRUCTION DETAILS

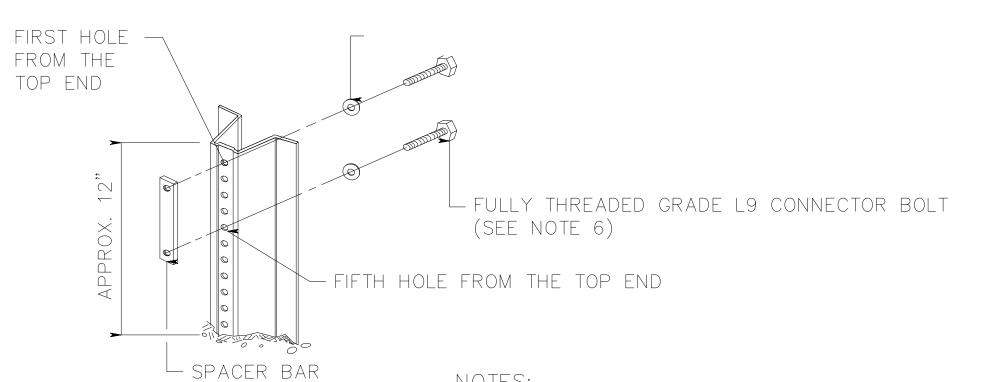

NOTES:


- 1. DRIVE ANCHOR POST ASSEMBLY TO WITHIN APPROXIMATELY 12 INCHES ABOVE GROUND LEVEL. PLACE BOLT AND WASHER IN FIRST AND FIFTH HOLES FROM THE TOP END, AND SECURE BOLTS ONTO SPACER.
- 2. DRIVE ANCHOR POST ASSEMBLY TO WITHIN A MAXIMUM OF 4 INCHES ABOVE GROUND LEVEL.
- 3 DIG OUT AROUND BACK OF ANCHOR POST ASSEMBLY TO ALLOW ROOM FOR TOP POST TO BE ATTACHED.
- 4. NEST TOP POST ASSEMBLY ONTO PROTRUDING ANCHOR POST ASSEMBLY BOLTS, THROUGH THE FIRST AND FIFTH HOLES FROM THE BOTTOM OF THE TOP POST.
- 5. PLACE AND TIGHTEN A SELF-LOCKING FLANGE NUT ON EACH BOLT. WHEN INSTALLATION IS COMPLETE, TOP OF GROUND POST SHALL NOT EXCEED 4 INCHES ABOVE GROUND LEVEL.
- 6. SIZE OF CONNECTOR BOLT FOR TYPE 1, 5/16" x 11/2" SIZE OF CONNECTOR BOLT FOR TYPE 2, $5/16" \times 2"$
- 7. THE CONNECTOR BOLTS SHALL BE FULLY THREADED. EACH CONNECTOR BOLT AND NUT SHALL BE CLEARLY STAMPED WITH MANUFACTURER'S IDENTIFYING MARK.

ANCHOR POST ASSEMBLY SIGN SUPPORTS

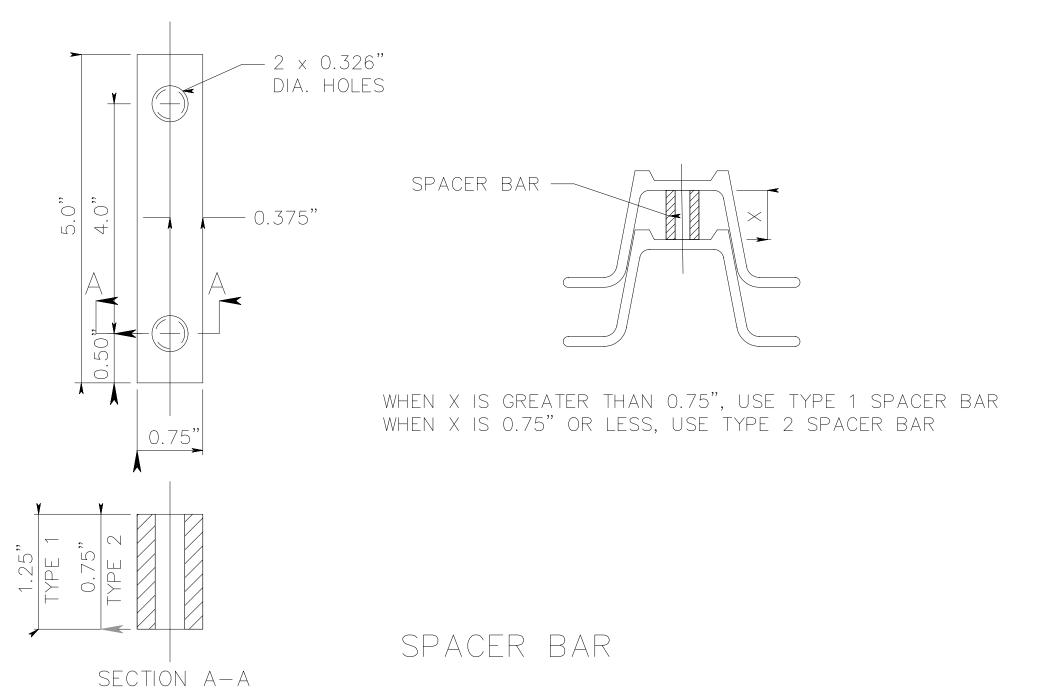

WEIGHT*		DIMENSIONS (IN) AREAX + X							
_BS. / FT.	", A	"B"	"C"	"□"	IN.2	I(IN. 4)	S(IN. 3)	I(IN. 4)	S(IN. 3)
2.50	1.516	3.062	1.278	0.669	0.760	0.228	0.313	0.539	0.352
4.00	1.968	3.500	1.336	0.834	1.187	0.611	0.707	1.161	0.664

TYPE 1 STEEL U-POST PROPERTIES ** GOVERNING SECTION

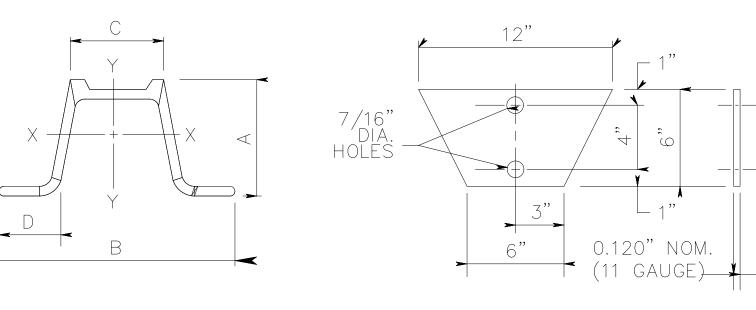

TYPE 1 STEEL


U-POST

TYPE 1 SOIL ANCHOR PLATE

8TH HOLE FROM THE TOP


TYPE 1 SOIL ANCHOR PLATE

> TYPE 1 STEEL U-POST

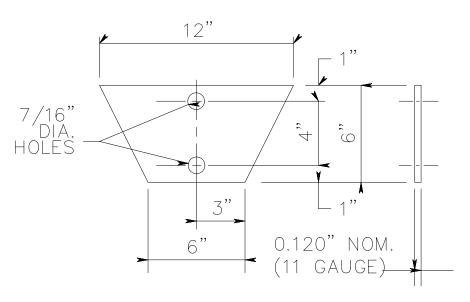





TYPE 2 STEEL U-POST PROPERTIES * 5% ** GOVERNING SECTION

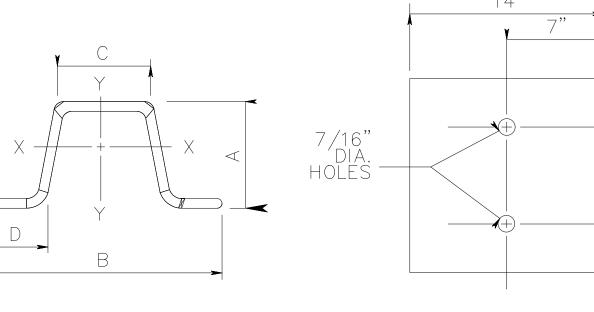

TYPE 2 STEEL U-POST

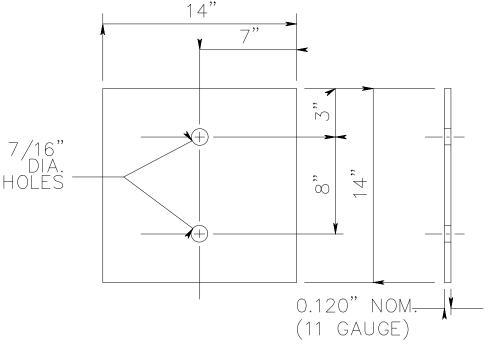

TYPE 2 SOIL ANCHOR PLATE

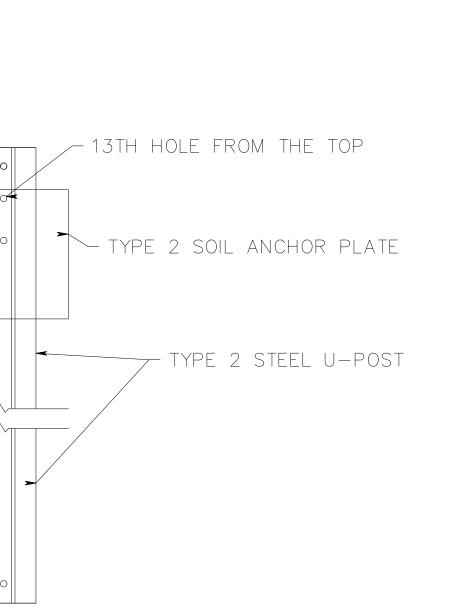

TYPE 2 ANCHOR POST ASSEMBLY

STEEL POSTS, POST CLIPS, SPACING, ETC.

AND TWO PIECE STEEL U-POSTS.

NOTES:

TYPE 1

ANCHOR POST

ASSEMBLY

Project Number

507393101-001

- 1. ANCHOR POST AND TOP POST SHALL BE OF EQUAL WEIGHT/FEET.
- 2. SOIL ANCHOR PLATE SHALL BE ATTACHED TO ALL ANCHOR POSTS.
- 3. THE MATERIAL FOR THE SOIL ANCHOR PLATES SHALL BE CARBON SHEET STEEL.
- 4. THE STEEL "U" POST SHALL BE GRADE 60.

STEEL U-POST SIGN SUPPORTS

TOP POST

U-POST

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TOWNSHIP OF CHATHAM MORRIS COUNTY, NEW JERSEY

Drawn Description Rev Date

JOHN K. RUSCH	ΚE
PROFESSIONAL ENGINEER	LIC. NO. 24GE0037148
John Rusell	
	Date 08-03-2023

Designed		RS	RS		Eng check	SJA		05/23	Tit
	Drawn	RS SJA		05/23	Coordination				
	Dwg check			05/23	Approved		JKR	05/23	
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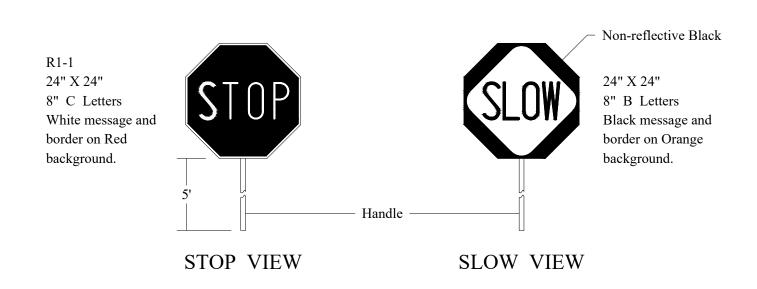
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CHATHAM TOWNSHIP PEDESTRIAN SAFETY AND ADA **IMPROVEMENTS**

CONSTRUCTION DETAILS

MACDONALD


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STOP / SLOW PADDLE

NOT TO SCALE

NOTE: Sign faces shall be reflective sheeting, Type II.



TYPE III BARRICADE — FRONT VIEW

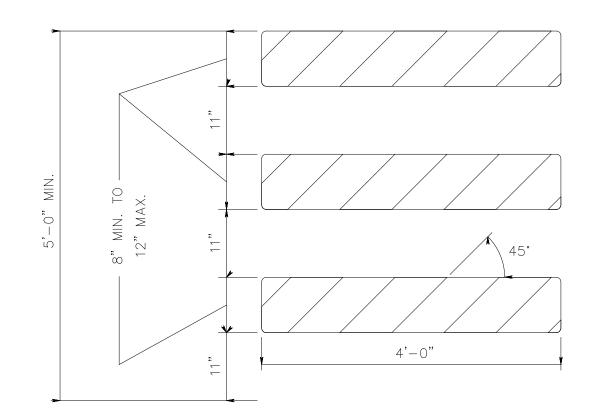NOTES:

- 1. ENSURE THE 8" MIN. x 48", TO 12" MAX. x 48" BARRICADE RAILS TO BE ATTACHED ACCORDING TO THE MANUFACTURER'S RECOMMENDATION.
- 2. ENSURE ORANGE AND SILVER (WHITE) STRIPES TO BE RETROREFLECTIVE SHEETING, ASTM D4956 TYPE III. ALTERNATE ORANGE AND SILVER (WHITE) STRIPES 6" WIDE SLOPING DOWNWARD AT AN ANGLE OF 45 DEGREES IN THE DIRECTION TRAFFIC IS TO PASS.
- 3. THE FRAMING, RAILS, AND BALLAST FOR BREAKAWAY BARRICADE TO BE NCHRP-350 CRASHED TESTED AND FHWA APPROVED.
- 4. IF NECESSARY, FABRICATE THE BALLAST AND PLACE ACCORDING TO THE MANUFACTURER'S RECOMMENDATION.

CD-159-1.3


BREAKAWAY BARRICADES NOT TO SCALE

ENSURE DRUMS ARE MADE OF ORANGE PLASTIC WITH A MINIMUM OF FOUR ALTERNATE FLUORESCENT ORANGE AND WHITE RETROREFLECTIVE STRIPES. IF THERE ARE

ENSURE RETROREFLECTIVE SHEETING FOR STRIPES CONFORMS WITH ASTM D4956 TYPE VII OR VIII WITH S2 REQUIREMENTS.

ENSURE THE TOP OF THE DRUM IS NOT OPEN. CONSTRUCT DRUMS TO INHIBIT ROLLING IF KNOCKED OVER.

ENSURE THE REFLECTORIZED AREA OF DRUMS IS ROUND EXCEPT OTHER SHAPES, WHICH PROVIDE THE SAME VISIBILITY AS AN 18 INCH DIAMETER ROUND DRUM REGARDLESS OF ORIENTATION, MAY BE USED.

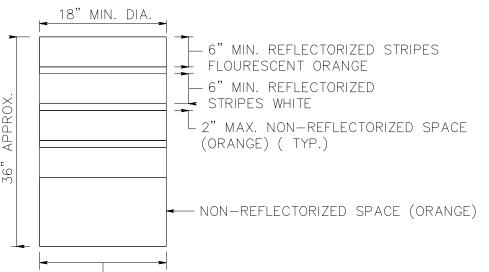


BASE DIA. MAY BE LARGER THAN TOP DIA.

WHEN BALLAST IS REQUIRED BY THE RE, USE SAND. THE MAXIMUM WEIGHT OF THE BALLAST IS 50 LBS. AND IS TO BE LOCATED APPROXIMATELY AT GROUND LEVEL. ALTERNATE TYPES OF BALLAST MUST BE APPROVED BY THE RE.

CD-159-1.1

DRUMS NOT TO SCALE

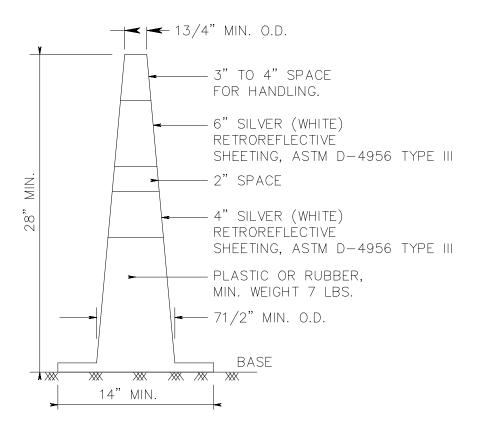

NOTES:

TRAFFIC CONES MUST BE PREDOMINATELY ORANGE IN COLOR. BASES MAY BE OF BREAKAWAY BALLASTED TYPE. MINOR MANUFACTURER'S VARIATIONS MAY BE ACCEPTABLE UPON APPROVAL OF THE RE.

CD-159-1.2

TRAFFIC CONES NOT TO SCALE

T-001

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						JOHN K PROFESSIO
						Zulin
						Project Number
Rev	Date	Drawn	Description	Ch'k'd	App'd	507393


JOHN K. RUSCHKE PROFESSIONAL ENGINEER LIC. NO. 24GE0037148 _ Date 08-03-2023

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CHATHAM TOWNSHIP PEDESTRIAN SAFETY AND ADA **IMPROVEMENTS**

TRAFFIC CONTROL DETAILS



TRAFFIC NOTES:

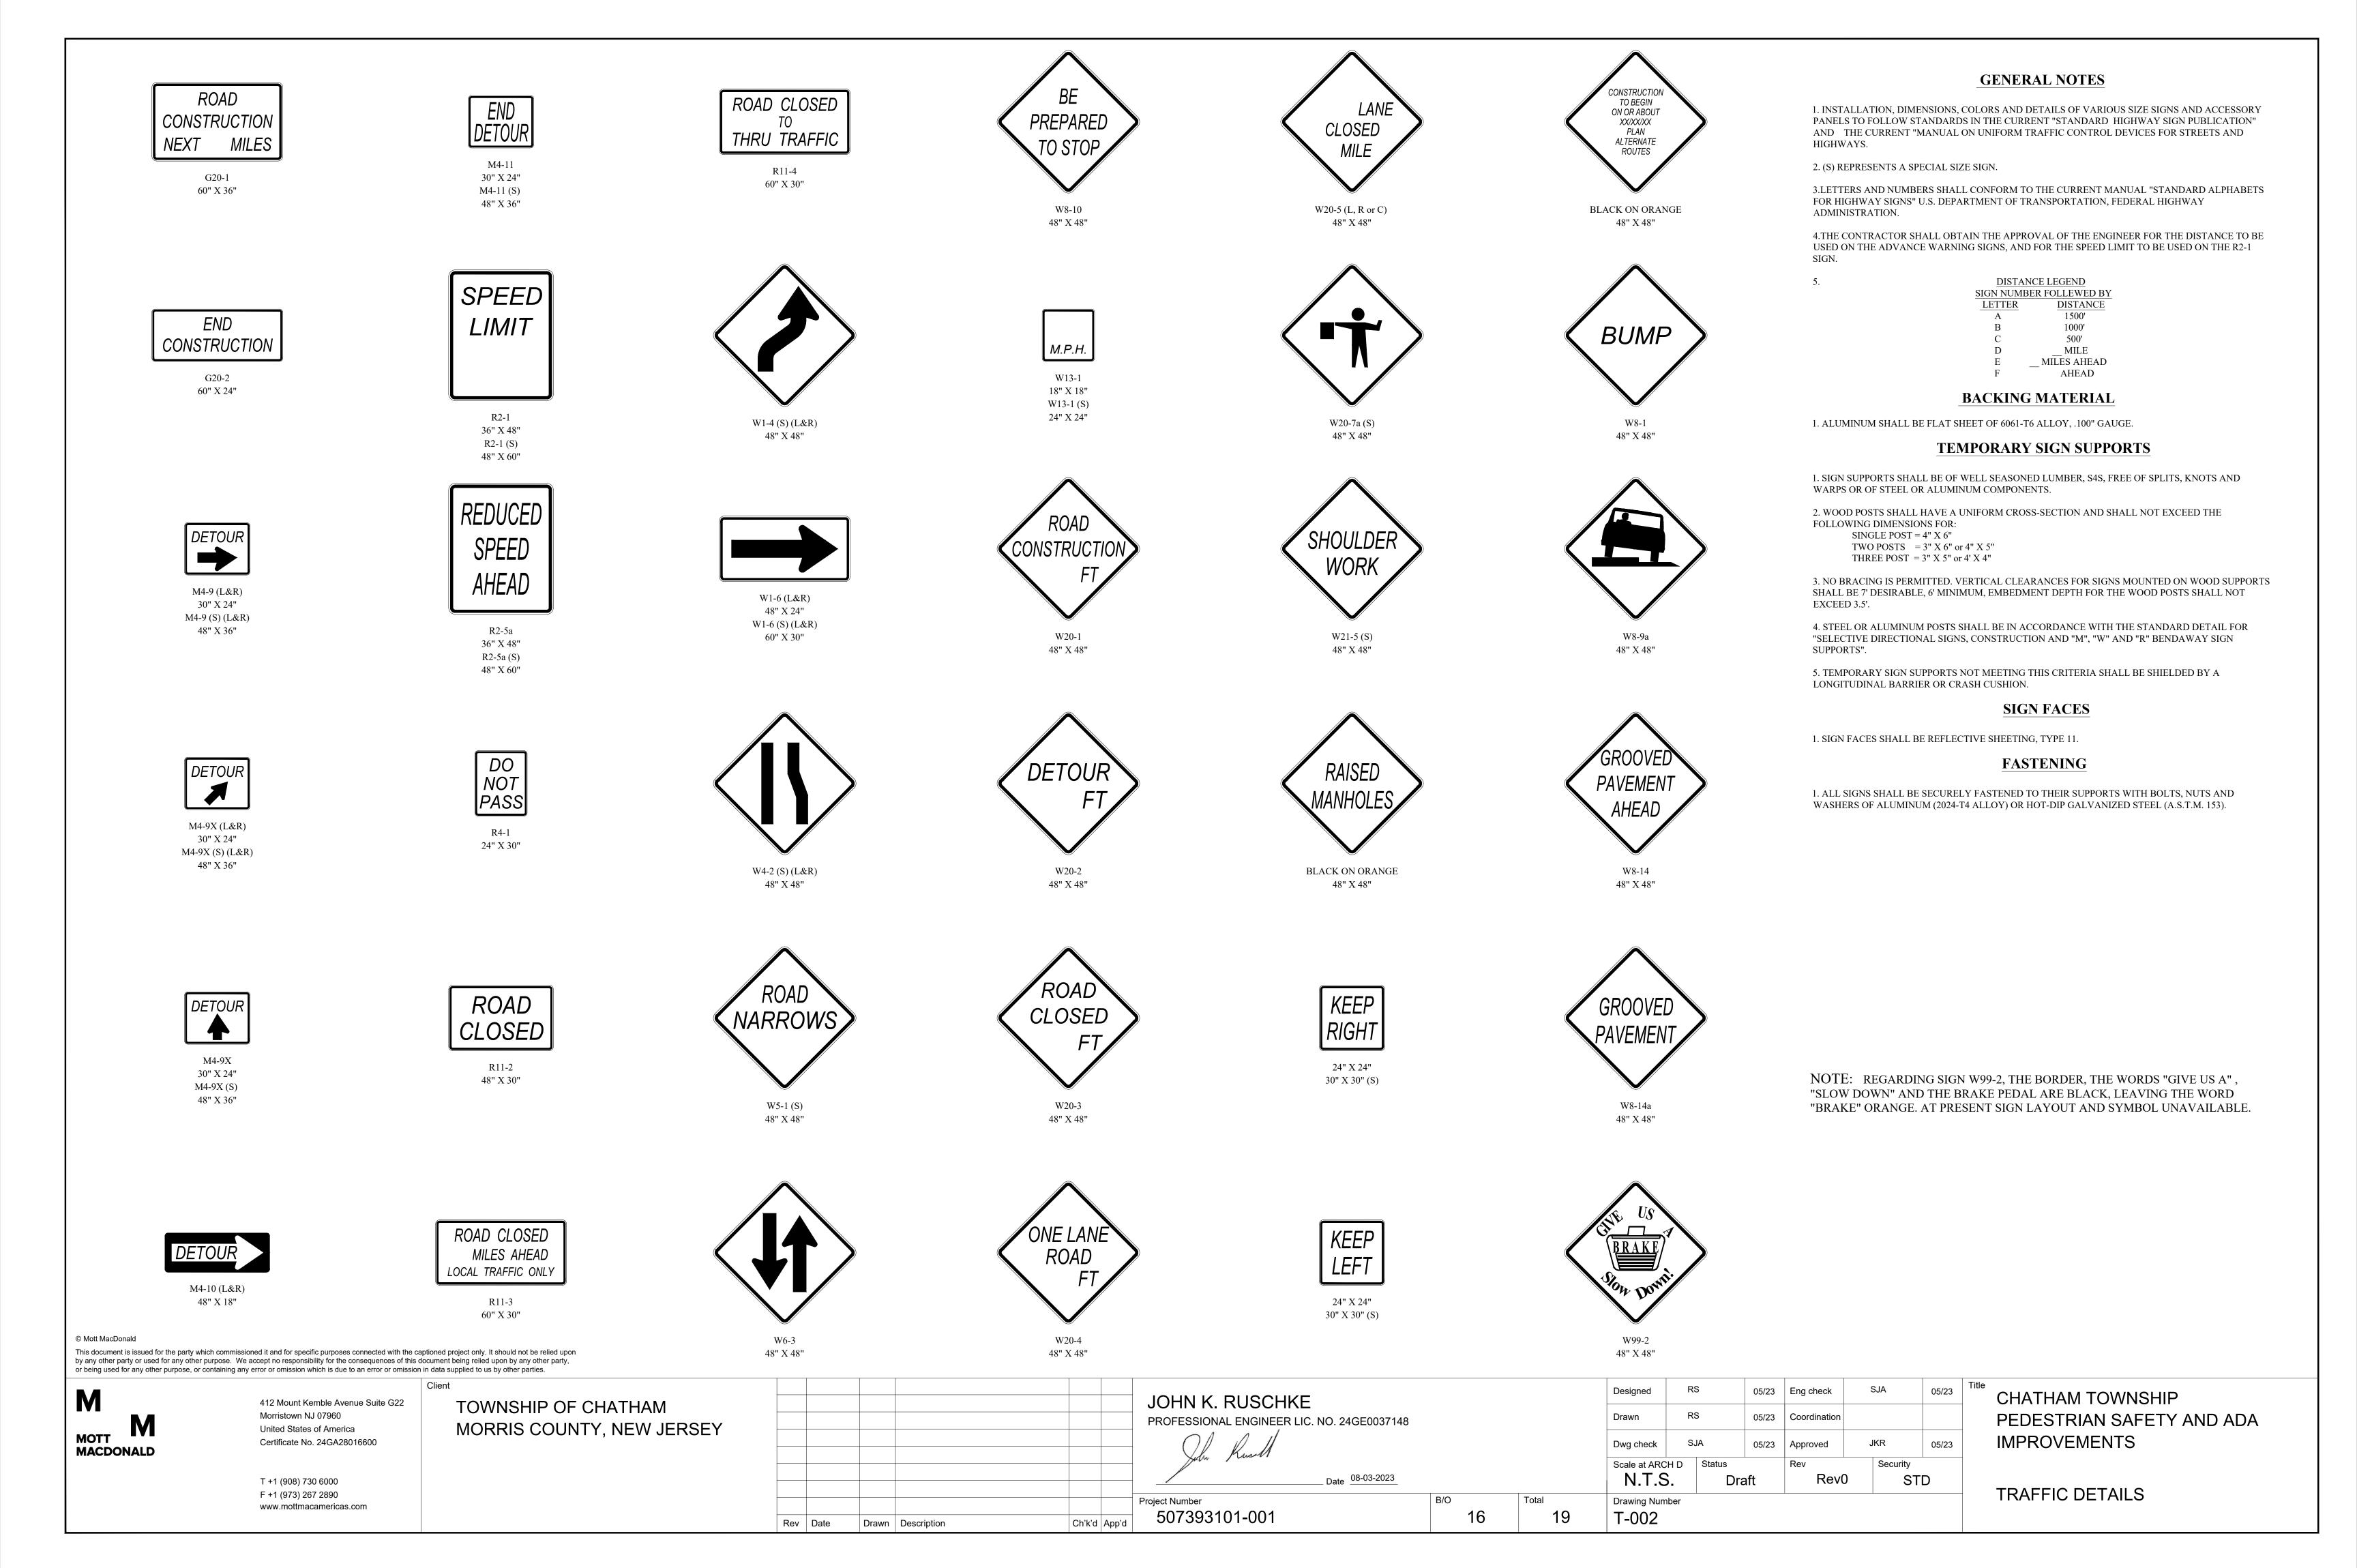- 1. ADVANCE WARNING SIGNS DISTANCES. AND TAPER LENGTHS MAY BE EXTENDED. AT DIRECTION OF THE DEPARTMENT, TO ADJUST FOR REDUCED VISIBILITY DUE TO HORIZONTAL AND VERTICAL CURVATURE OF THE ROADWAY.
- 2. THE APPROXIMATE LOCATIONS OF THE ILLUMINATED FLASHING ARROW BOARDS ARE SHOWN ON THE TRAFFIC CONTROL PLANS. THESE LOCATIONS MAY BE MODIFIED AS APPROVED BY RE TO ADJUST FOR VISIBILITY DUE TO HORIZONTAL OR VERTICAL CURVATURE OF THE ROADWAY OR TO POSITION AT A SAFER LOCATION. ILLUMINATED FLASHING ARROW BOARDS ARE TO BE USED FOR TEMPORARY LANE CLOSINGS AND AT LOCATIONS SHOWN ON THE TRAFFIC CONTROL PLANS.
- 3. PRIOR TO ANY ROAD CONSTRUCTION, TRAFFIC CONTROL SIGNS AND DEVICES SHALL BE IN PLACE.
- 4. RAMPS AND/OR SIDE STREETS ENTERING THE ROADWAY AFTER THE FIRST ADVANCE WARNING SIGN SHALL BE PROVIDED WITH AT LEAST ONE W20-IF SIGN (ROAD WORK AHEAD) AS A MINIMUM.
- 5. ALL EXISTING ROAD SIGNS, PAVEMENT MARKINGS AND/OR PLOWABLE PAVEMENT REFLECTORS WHICH CONFLICT WITH THE PROPOSED TRAFFIC CONTROL PLAN SHALL BE COVERED, REMOVED OR RELOCATED AS DIRECTED BY THE RE.
- 6. CONFLICTING OR NON-OPERATING SIGNAL INDICATIONS ON EITHER THE EXISTING, TEMPORARY,OR PROPOSED TRAFFIC SIGNAL SYSTEMS SHALL BE BAGGED OR COVERED.
- 7. MAINTENANCE AND PROTECTION OF TRAFFIC SHALL BE IN ACCORDANCE WITH THE MANUAL OF UNIFORM TRAFFIC CONTROL DEVICES — PART VI "STANDARDS AND GUIDES FOR TRAFFIC CONTROL FOR STREET AND HIGHWAY CONSTRUCTION, MAINTENANCE, UTILITY, AND INCIDENT MANAGEMENT OPERATIONS", UNLESS OTHERWISE NOTED IN THE PLANS AND SPECIFICATIONS.
- 8. CONSTRUCTION SIGN W99-2 (GIVE US A BRAKE) SHALL BE LOCATED 200 FEET IN ADVANCE OF PROJECT LIMITS.
- 9. A W1-6 (ARROW) SIGN MOUNTED ON A BREAKAWAY BARRICADE AND CENTERED ON THE CLOSED WIDTH SHALL BE LOCATED 100 FEET BEYOND EACH INTERSECTION OR MAIN ACCESS POINT WITHIN THE AREA OF A LANE OR SHOULDER CLOSURE.
- 10. CONSTRUCTION SIGNS R11-4 (ROAD CLOSED TO THRU TRAFFIC) SHALL BE PLACED AT THE INTERSECTING STREETS WHICH ARE CLOSED TO TRAFFIC BECAUSE OF CONSTRUCTION.
- 11. CONSTRUCTION SIGNS W8-9A (SYMBOL FOR UNEVEN PAVEMENT) AND W8-14A (GROOVED PAVEMENT) SHALL BE USED WHEN SUCH PAVEMENT CONDITIONS EXIST. THE PLACEMENT OF THESE SIGNS SHALL BE AS DIRECTED BY THE RE.
- 12. MOVING WORK AREAS IN A LANE CLOSURE REQUIRE A TRAILER MOUNTED ILLUMINATED FLASHING ARROW TO REMAIN AT THE END OF THE TAPER, THE TRAFFIC CONTROL TRUCK WITH MOUNTED CRASH CUSHION THAT SHALL MOVE WITH THE WORK AREAS TO KEEP A 70 FEET MIN. AND 150 FEET MAX. BUFFER IN ADVANCE OF EACH WORK AREA.
- 13. THE CONTRACTOR SHALL SUBMIT A PLAN FOR THE SAFE ACCESS OF CONSTRUCTION VEHICLES THROUGHOUT THE WORK SITE WHERE SPACE CONSTRAINTS PREVENT THE USE OF LANE CLOSURES. THE PLAN SHALL BE SUBMITTED TO THE RE IN ACCORDANCE WITH THE STANDARD SPECIFICATIONS.
- ALL EXCAVATED AREAS WITHIN OR ADJACENT TO THE ROADWAY SHALL BE BACKFILLED AND PLACED ON AT LEAST 6H: 1V SLOPE BEFORE THE END OF EACH WORK DAY. OTHER EXCAVATED AREA WITHIN THE CLEAR ZONE SHALL BE BACKFILLED.
- 15. WHERE REQUIRED, THE CONTRACTOR SHALL MAKE PROVISIONS FOR MAINTAINING PEDESTRIAN CROSSING LOCATIONS AND TYPE AS DIRECTED BY THE RE.
- 16. BITUMINOUS CONCRETE PLACED DURING THE VARIOUS CONSTRUCTION STAGES SHALL BE TRANSITIONED ON A MINIMUM 20H: 1V SLOPE TO MEET THE ADJACENT EXISTING GRADE AT THE LONGITUDINAL AND TRANSVERSE LIMITS OF THE STAGE CONSTRUCTION AREAS UNLESS OTHERWISE NOTED ON THE STAGE CONSTRUCTION PLANS.
- 17. THE PLACEMENT AND OR RELOCATION OF PRECAST CONCRETE CURB, CONSTRUCTION BARRIER SHALL BE DONE DURING APPROVED OFF-PEAK HOURS WHEN TRAFFIC MAY BE REDUCED TO ONE LANE IN EACH DIRECTION.
- 18. CONSTRUCTION ZONE SPEED LIMIT WILL BE DETERMINED BY THE TRAFFIC SIGNAL & SAFETY ENGINEERING, REGIONAL TRAFFIC ENGINEER - WORK ZONE, AT THE TIME OF OR DURING CONSTRUCTION, AS REQUESTED BY THE R.E..
- 19 . The speed limit, R2-1 (black on white) with added work zone plate (black ON ORANGE) SIGNS SHALL BE LOCATED THROUGH WORK AREAS AS DIRECTED BY THE TRAFFIC SIGNAL & SAFETY ENGINEERING REGIONAL TRAFFIC ENGINEER - WORK ZONE.
- 20. The reduced speed ahead sign, W3-5(S) (black on orange) shall be located IN ADVANCE OF SPEED LIMIT R2-1 SIGNS WHICH REDUCE THE NORMAL POSTED SPEED LIMIT THROUGH THE CONSTRUCTION ZONE.
- 21. TRAFFIC FINES DOUBLED IN WORK AREA R(NJ)5-17(S), 4 FEET BY 2.5 FEET SIGN SHALL BE LOCATED 500 FEET AFTER THE FIRST ADVANCE WARNING SIGN, (W20 SERIES) AT EACH WORK AREA LOCATED WITHIN URBAN AREAS. THIS SIGN SHALL ALSO BE USED ON PROJECTS REQUIRING MOVING OPERATIONS IN WHICH CASE THE SIGN SHALL BE MOUNTED ON A SLOW MOVING CONSTRUCTION VEHICLE.
- 22. THE FINAL HMA SURFACE PAVEMENT SHALL NOT BE CONSTRUCTED UNTIL THE FINAL STAGE OF THE PROJECT UNLESS OTHERWWISE DIRECTED BY THE RE OR INDICATED ON THE PLANS. MANHOLES AND INLETS SHALL BE SET TO FINISHED GRADE AND TEMPORARY PAVEMENT RAMPS ARE TO BE CONSTRUCTED AROUND THEM WITH A MINIMUM 20H : 1V SLOPE IN ALL DIRECTIONS USING HOT MIX ASPHALT PAVEMENT. THIS TEMPORARY MATERIAL WILL BE REMOVED IMMEDIATELY PRIOR TO PLACING THE SURFACE COURSE.

- 23. TRAFFIC CONTROL DEVICES FOR LANE CLOSURES INCLUDING SIGNS, CONES, BARRICADES, ETC. SHALL BE PLACED AS SHOWN ON PLANS. SIGNS SHALL NOT BE PLACED WITHOUT ACTUAL LANE CLOSURES AND SHALL BE IMMEDIATELY REMOVED UPON REMOVAL OF THE CLOSURES.
- 24. CONES MAY BE SUBSTITUTED FOR DRUMS AND INSTALLED UPON THE APPROVAL OF THE RE.
- 25. TRAFFIC IMPACT NOTICES AND CHANGES

WHEN THE FOLLOWING TERMS ARE USED, THE INTENT AND MEANING SHALL BE AS FOLLOWS:

IMPACTS TO NORMAL TRAFFIC FLOW — WORK THAT REQUIRES A PORTION OF THE PAVED ROADWAY BEING BLOCKED OR CLOSED WITH SAFETY DEVICES OR VEHICLES, INCLUDING, BUT NOT LIMITED TO, FULL OR PARTIAL LANE CLOSURES, FULL OR PARTIAL RAMP CLOSURES, SHOULDER CLOSURES, MOVING OPERATIONS SUCH AS TRAFFIC STRIPING OR SWEEPING, LANE SHIFTS, OR ALTERNATING TRAFFIC. THIS APPLIES EVEN WHEN DETOURS ARE PROVIDED.

ii. Temporary lane closures — work described under "impacts to normal traffic FLOW" WHICH IS ROUTINELY SET UP AND REMOVED ON A DAILY BASIS.

iii. PERMANENT LANE CLOSURES — WORK DESCRIBED UNDER "IMPACTS TO NORMAL TRAFFIC FLOW" WHICH REMAINS IN PLACE CONTINUOUSLY FOR 24 HOURS OR MORE.

B. ADVANCE NOTICES

FOR THE INITIAL START OF WORK THAT REQUIRES "IMPACTS TO NORMAL TRAFFIC FLOW", THE CONTRACTOR SHALL NOTIFY THE RE IN WRITING, ON THE ADVANCE FORM TO-103 PROVIDED BY THE DEPARTMENT, OF THE PROPOSED DATE. THE NOTICE SHALL BE SUBMITTED AT LEAST TWENTY-EIGHT CALENDAR DAYS, BUT NOT MORE THAN SIXTY CALENDAR DAYS, BEFORE THE PROPOSED DATE. START OF WORK THAT IMPACTS NORMAL TRAFFIC FLOW WILL NOT BE PERMITTED PRIOR TO THE DATE STATED IN THE NOTICE. THE CONTRACTOR SHALL CONFIRM, IN WRITING TO THE RE, THE PROPOSED DATE SEVEN (AND/OR FOURTEEN) CALENDAR DAYS BEFORE STARTING THE ESTÁBLISHMENT OF THE TRAFFIC CONTRÓL MEASURES FOR THE TRAFFIC IMPACT. THE CONTRACTOR SHALL IMMEDIATELY NOTIFY THE RE IF THE PROPOSED ESTABLISHMENT CAN NOT BE COMPLETED ON THE PROPOSED DATE.

FOR A "PERMANENT LANE CLOSURE". THE CONTRACTOR SHALL NOTIFY THE RE IN WRITING, ON ADVANCE FORM TO-103, OF THE PROPOSED DATE A NEW TRAFFIC PATTERN WILL BE ESTABLISHED. THE NOTICE SHALL BE SUBMITTED AT LEAST TWENTY-EIGHT CALENDAR DAYS, BUT NOT MORE THAN SIXTY CALENDAR DAYS, IN ADVANCE OF THE PROPOSED DATE. START OF A NEW TRAFFIC PATTERN WILL NOT BE PERMITTED PRIOR TO THE DATE STATED IN THE NOTICE. THE CONTRACTOR SHALL CONFIRM, IN WRITING TO THE RE, THE PROPOSED DATE OF THE NEW TRAFFIC PATTERN SEVEN (AND/OR FOURTEEN) DAYS BEFORE STARTING TRAFFIC CONTROL MEASURES FOR THE ESTABLISHMENT ÒF THE NEW PATTERN. THE CONTRACTOR SHALL IMMEDIATELY NOTIFY THE RE IF THE PROPOSED ESTABLISHMENT CAN NOT BE COMPLETED ON THE PROPOSED DATE.

STARTING THE ESTABLISHMENT OF A NEW PERMANENT TRAFFIC PATTERN SHALL BEGIN NO EARLIER THAN 11:00 PM FRIDAY AND SHALL BE COMPLETED AND READY FOR OPERATIONS BY 6:00 PM THE FOLLOWING SUNDAY. THE ESTABLISHMENT SHALL BE COMPLETED IN ACCORDANCE WITH THE LANE CLOSURE HOURS SPECIFIED IN THE CONTRACT.

ADVANCE NOTICES SENT PRIOR TO THE PRE-CONSTRUCTION MEETING SHALL BE ADDRESSED TO THE CONTACT PERSON AS SPECIFIED IN SUBSECTION 101.04 OF THE SPECIAL PROVISIONS.

C. PROGRESS NOTICES

ALL "IMPACTS TO NORMAL TRAFFIC FLOW" SCHEDULED FOR THE SEVEN DAY PERIOD STARTING ON THE FOLLOWING MONDAY SHALL BE SUBMITTED TO THE RE BY 9:00 AM OF EACH FRIDAY ON WEEKLY FORM TO-100 PROVIDED BY THE DEPARTMENT.

EACH DAY OF "TEMPORARY LANE CLOSURES" SHALL BE SUBMITTED TO THE RE BY 9:00 AM THE DAY IN ADVANCE OF THE START OF THOSE OPERATIONS ON DAILY FORM TO-101 PROVIDED BY THE DEPARTMENT. "TEMPORARY LANE CLOSURES" FOR WEEKENDS SHALL BE SUBMITTED TO THE RE BY 9:00 AM ON THE MMEDIATELY PRECEDING FRIDAY ON THE DAILY FORM TO-101 PROVIDED BY THE DEPARTMENT.

D. CHANGES TO THE SCHEDULED CLOSURES

REQUEST FOR A CHANGE TO THE TRAFFIC CONTROL REQUIREMENTS IN THE CONTRACT DOCUMENTS SHALL BE SUBMITTED IN WRITING TO THE RE AS FOLLOWS:

CHANGES TO THE SCHEDULED HOURS FOR "TEMPORARY LANE CLOSURES" SHALL BE SUBMITTED TO THE R.E. AT LEAST EIGHT CALENDAR DAYS IN ADVANCE OF WHEN THE CHANGE IS PROPOSED TO START.

OTHER PROPOSED CHANGES TO "TEMPORARY LANE CLOSURES" AND ALL CHANGES TO "PERMANENT LANE CLOSURES" SHALL BE SUBMITTED TO THE RE AS SPECIFIED IN THE SPECIFICATIONS.

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Drawn Description Ch'k'd App'd Rev Date

JOHN K. RUSCHKE PROFESSIONAL ENGINEER LIC. NO. 24GE0037148

Date <u>08-03-2023</u> 507393101-001

SJA 05/23 Eng check Designed RS 05/23 Coordination Drawn JKR 05/23 05/23 Dwg check Approved Scale at ARCH D Status Security N.T.S. Rev0 STD Draft Drawing Number


CHATHAM TOWNSHIP PEDESTRIAN SAFETY AND ADA **IMPROVEMENTS**

TRAFFIC CONTROL DETAILS

Project Number

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T-003

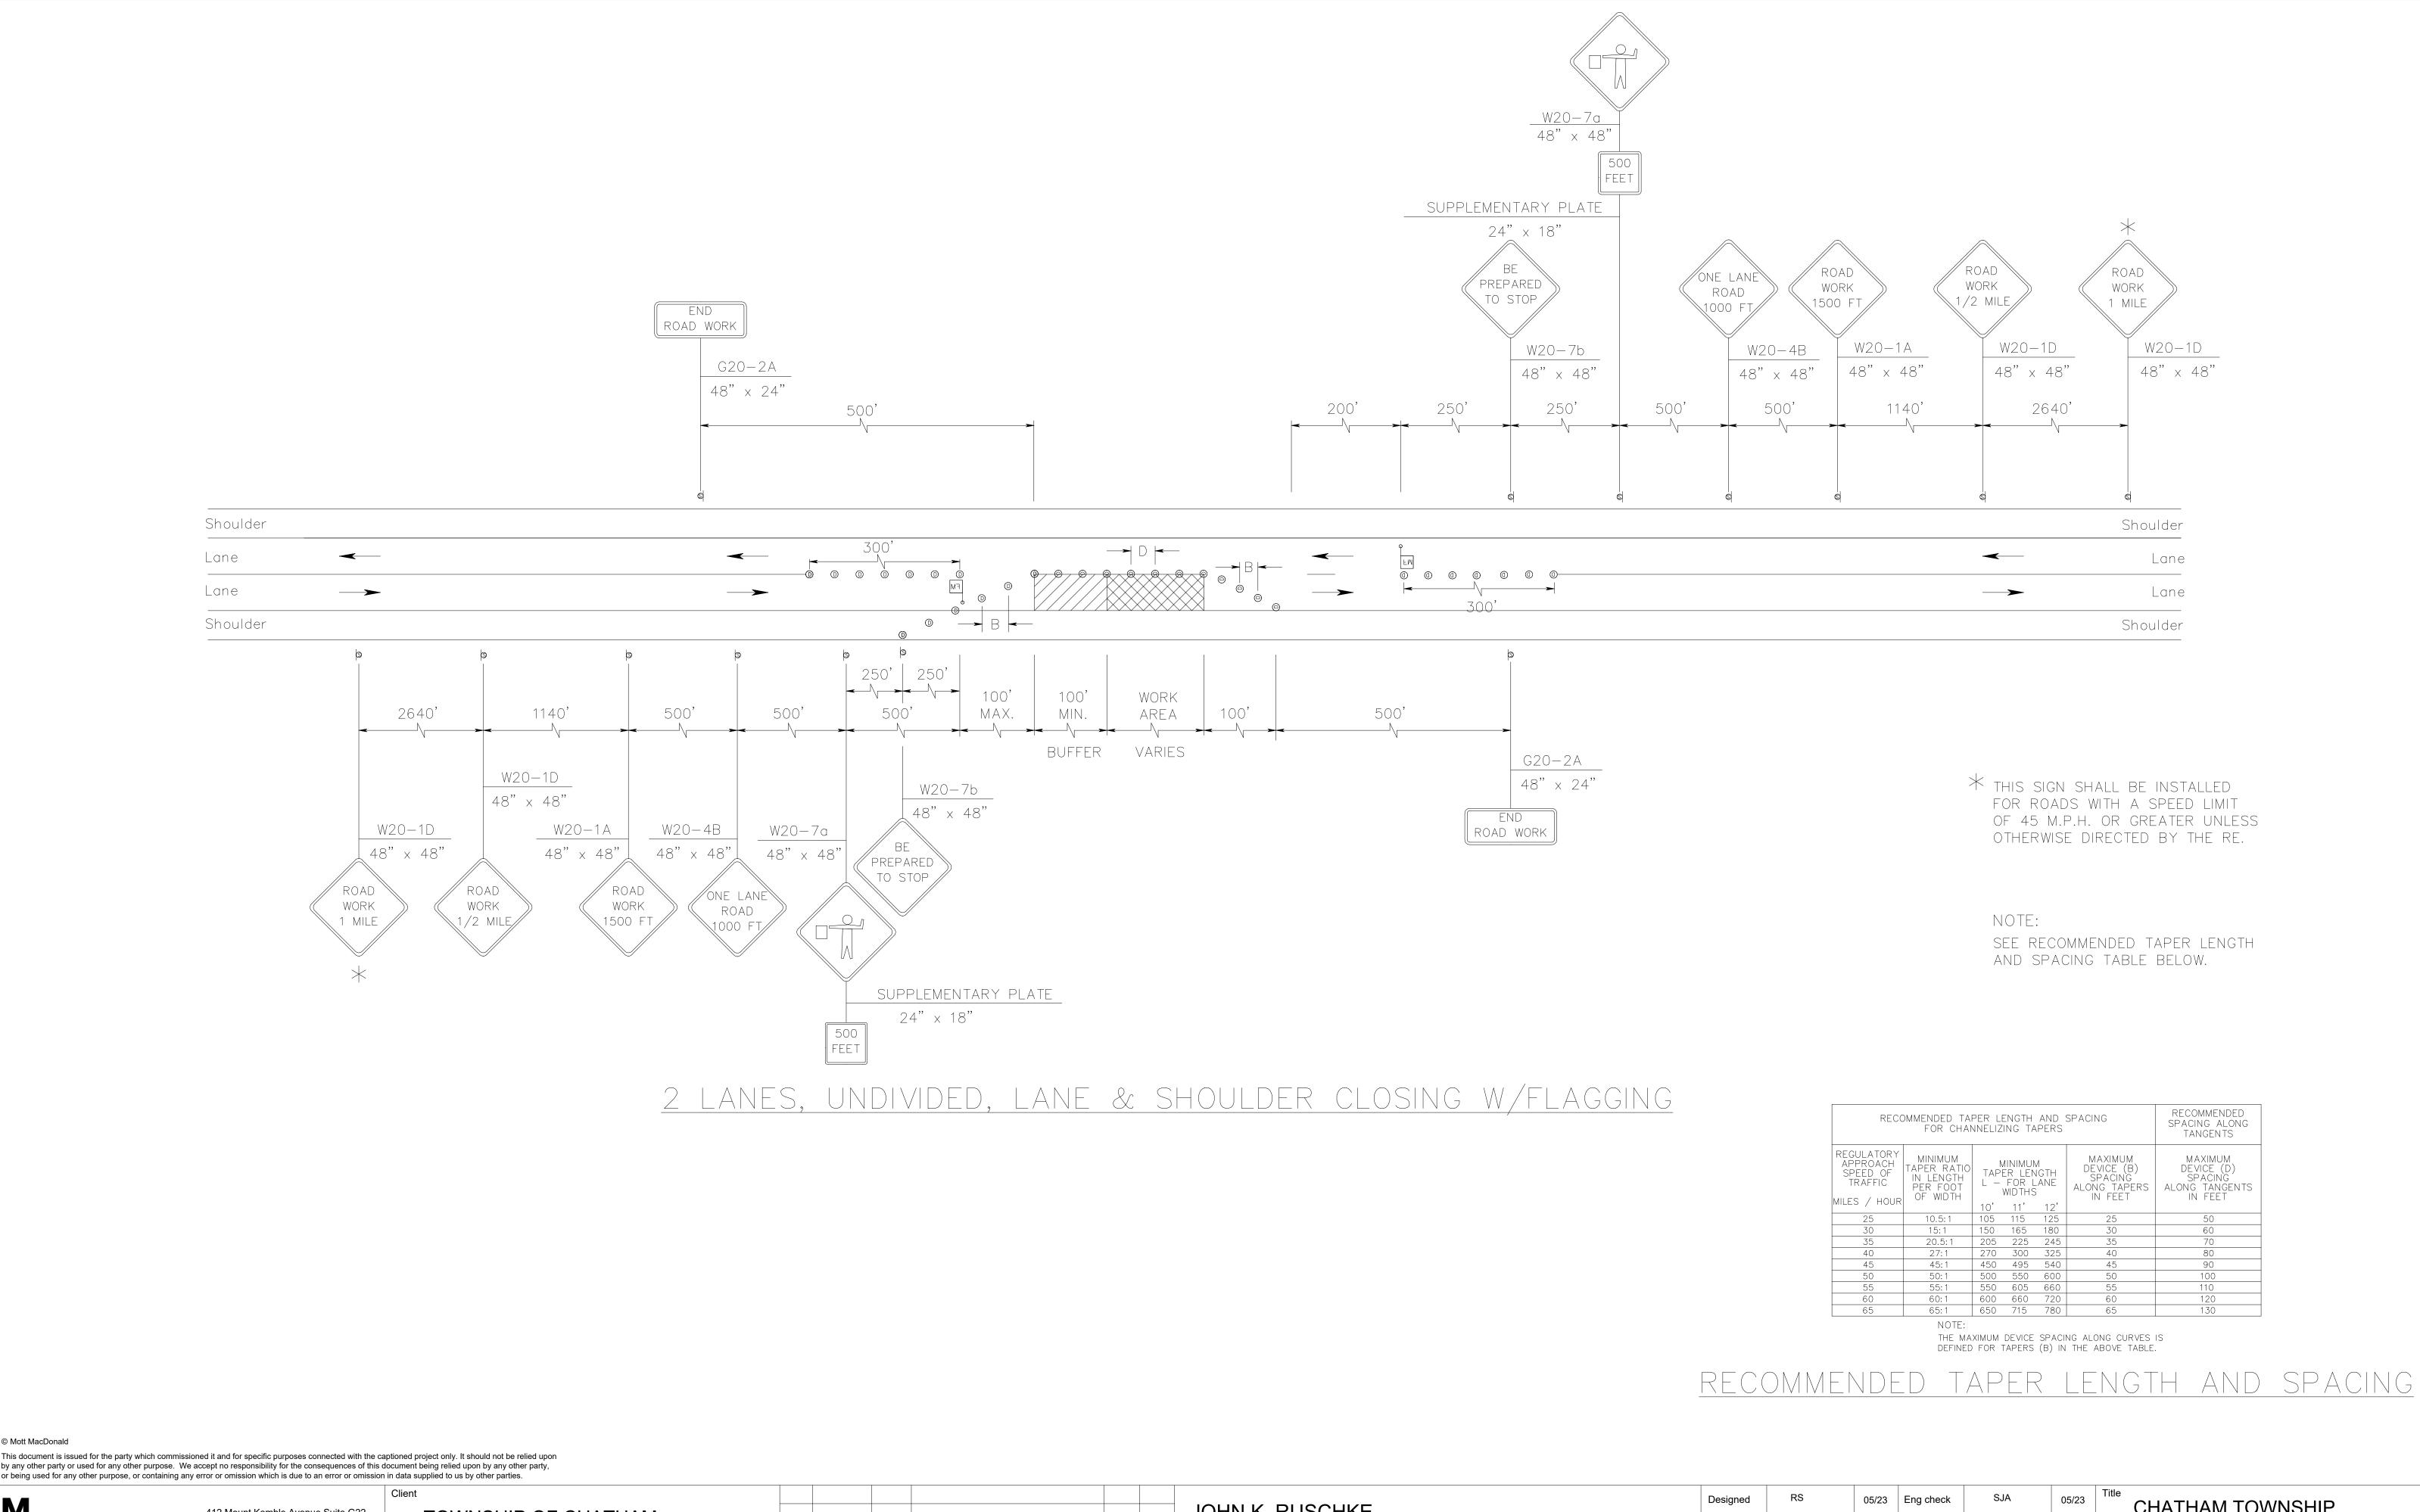

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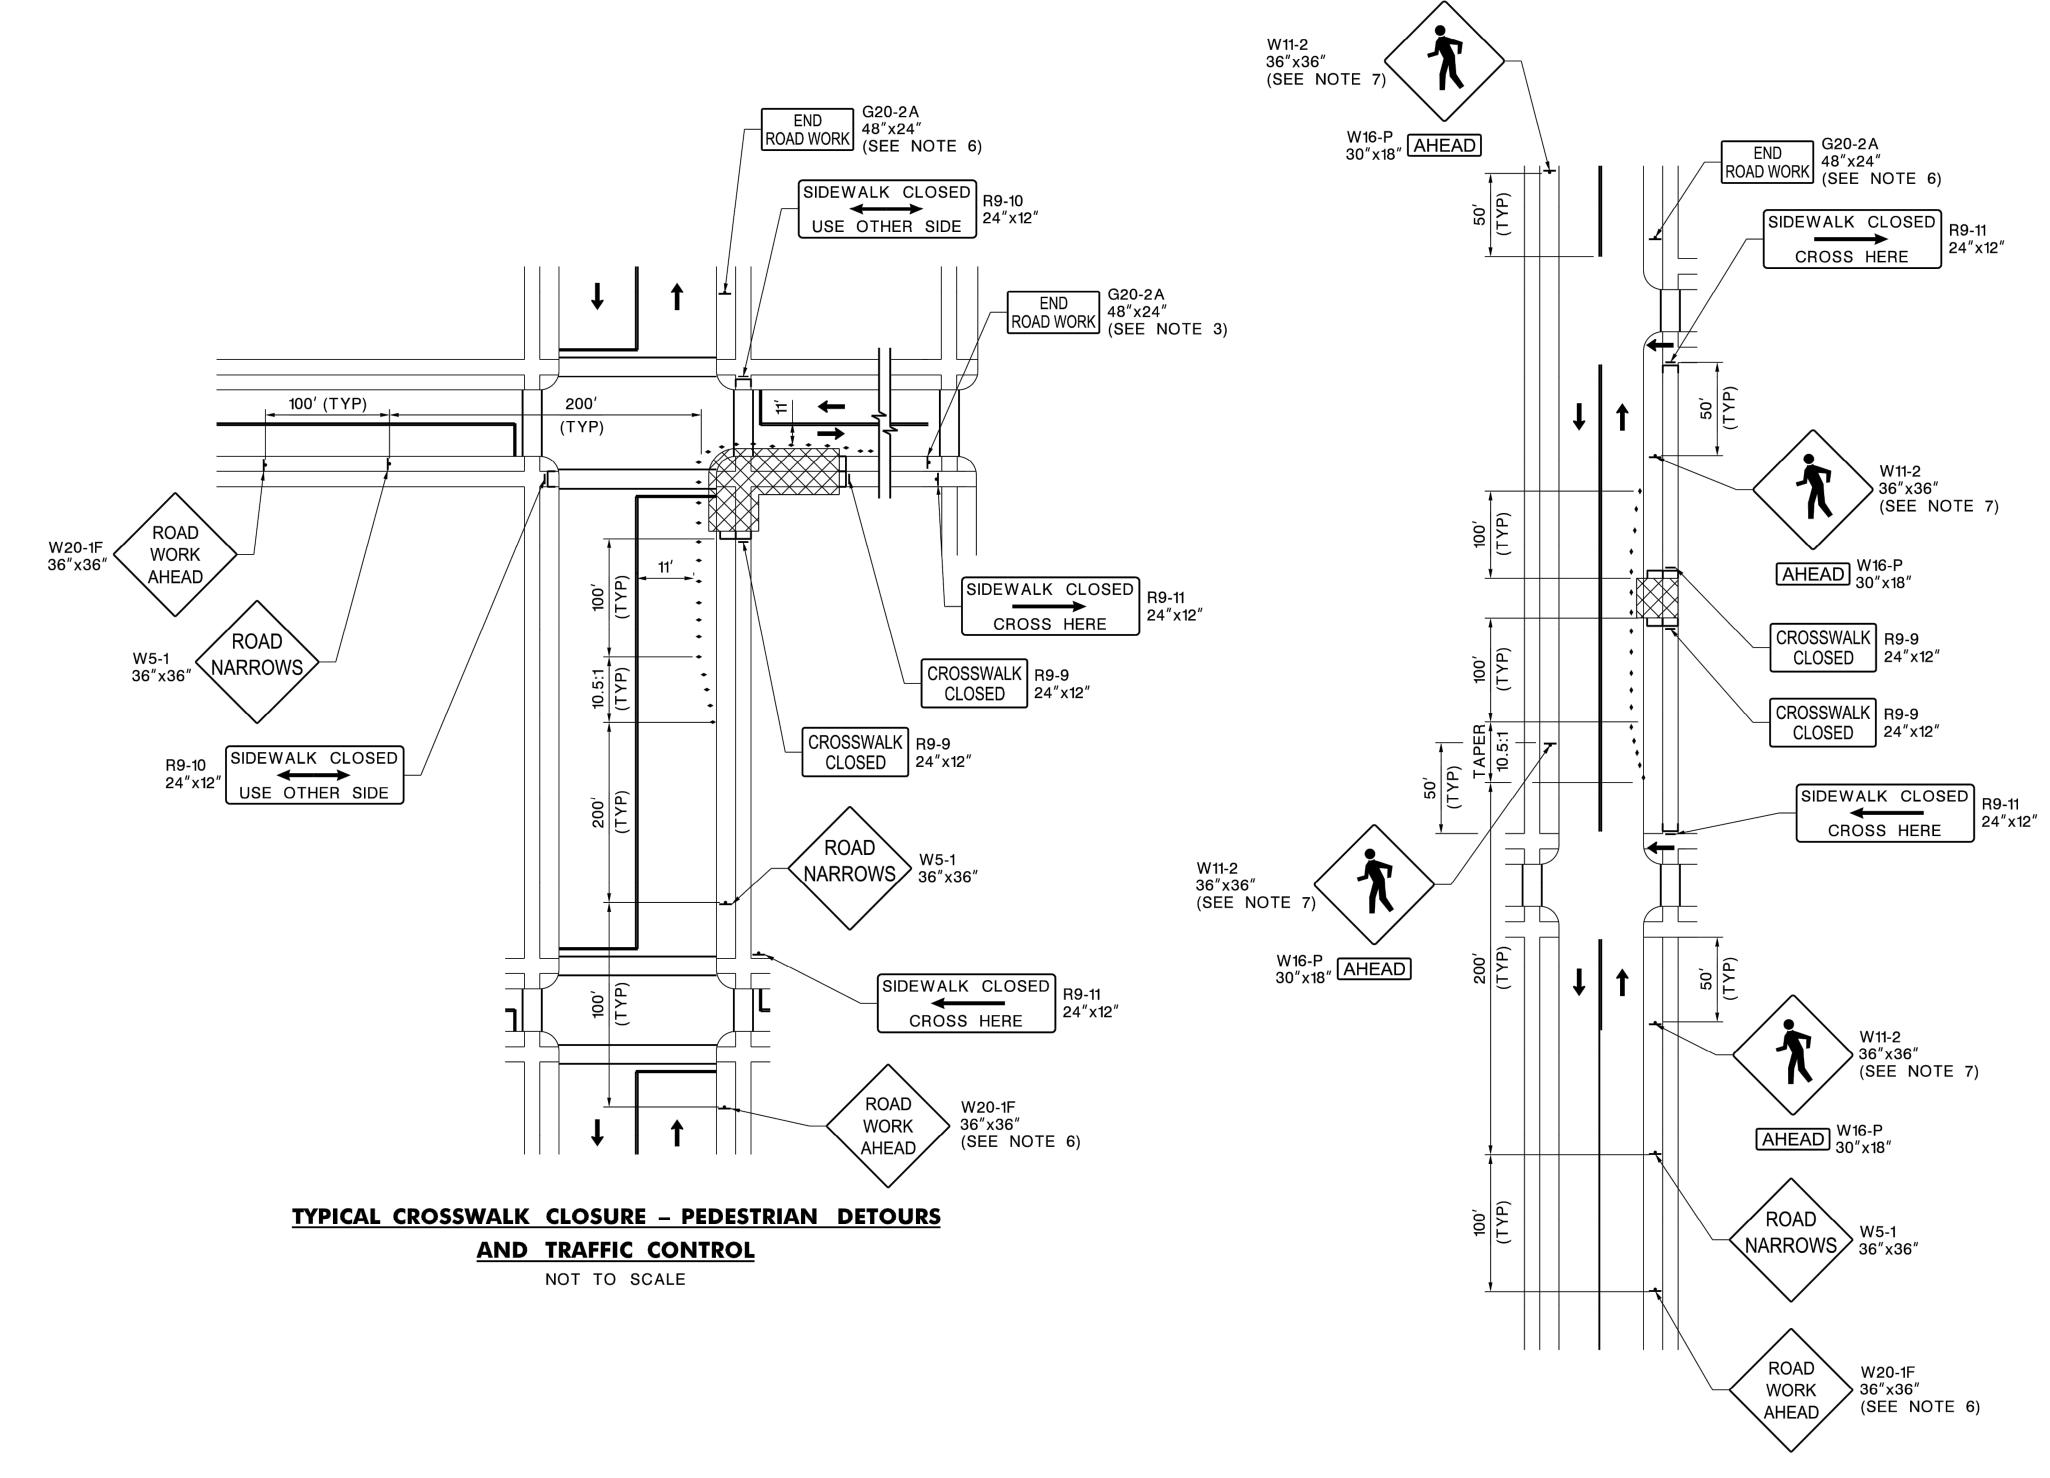
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CHATHAM TOWNSHIP PEDESTRIAN SAFETY AND ADA **IMPROVEMENTS**

TRAFFIC CONTROL DETAILS

NOTES - TRAFFIC CONTROL FOR SIDEWALK AND CURB RAMP WORK

- . WHEN CROSSWALKS OR OTHER PEDESTRIAN FACILITIES ARE CLOSED OR RELOCATED, TEMPORARY FACILITIES SHALL BE DETECTABLE AND SHALL INCLUDE ACCESSIBILITY FEATURES CONSISTENT WITH THE FEATURES PRESENT IN THE EXISTING PEDESTRIAN FACILITY.
- 2. TYPICAL DISTANCE BETWEEN CONES IS 12'.
- 3. THE RECOMMENDED LANE WIDTH IN THE PROXIMITY OF THE WORK ZONE IS 11'. THE TEMPORARY LANE WIDTH MAY BE REDUCED TO 10' WITH THE RE APPROVAL.
- 4. BEFORE BEGINNING WORK AT ANY INTERSECTION, THE CONTRACTOR SHALL COORDINATE WITH THE BOROUGH TO IMPLEMENT TEMPORARY PARKING RESTRICTION FOR MINIMUM 300' IN ADVANCE OF THE WORK ZONE.
- 5. MULTIPLE WORK ZONES CAN BE SET UP ALONG THE SAME STREET ONLY IF ADEQUATE PEDESTRIAN DETOUR AND/OR SIDEWALK DIVERSION CAN BE IMPLEMENTED FOR EACH WORK ZONE.
- 6. INSTALL W20-1 AND G20-2A ONLY AT THE BEGINNING AND RESPECTIVELY AT THE END OF THE CORRIDOR, IF MORE THAN ONE INTERSECTION IS IMPROVED ALONG THE SAME STREET.
- 7. IF THE APPROACH IS STOP CONTROLLED INSTALLATION OF W11-2/W16-9P IS OPTIONAL.



TYPICAL SIDEWALK DETOURS
AND TRAFFIC CONTROL

NOT TO SCALE

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Drawn Description

Rev Date

JOHN K. RUSCHKE

PROFESSIONAL ENGINEER LIC. NO. 24GE0037148

Line Land

Date 08-03-2023

Project Number

Ch'k'd App'd

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CHATHAM TOWNSHIP
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IMPROVEMENTS

TRAFFIC CONTROL DETAILS