CHOWDHURY PROPERTY 93 SUNSET DRIVE LOT DEVELOPMENT PLAN & STEEP SLOPES VARIANCE PLAN

BLOCK 62.09 TOWNSHIP OF CHATHAM MORRIS COUNTY, NEW JERSEY


YANNACCONE VILLA

& ALDRICH, LLC 460 MAIN STREET, P.O. BOX 459 CHESTER, NEW JERSEY 07930

KEY MAP

PHONE: 908-879-6646 FAX: 908-879-8591 N.J. STATE BOARD FOR P.E. & P.L.S. CERTIFICATE OF AUTHORIZATION No. 24GA27934500

AND LAND SURVEYOR No. 42575 NOT VALID WITHOUT SIGNATURE AND RAISED SEA

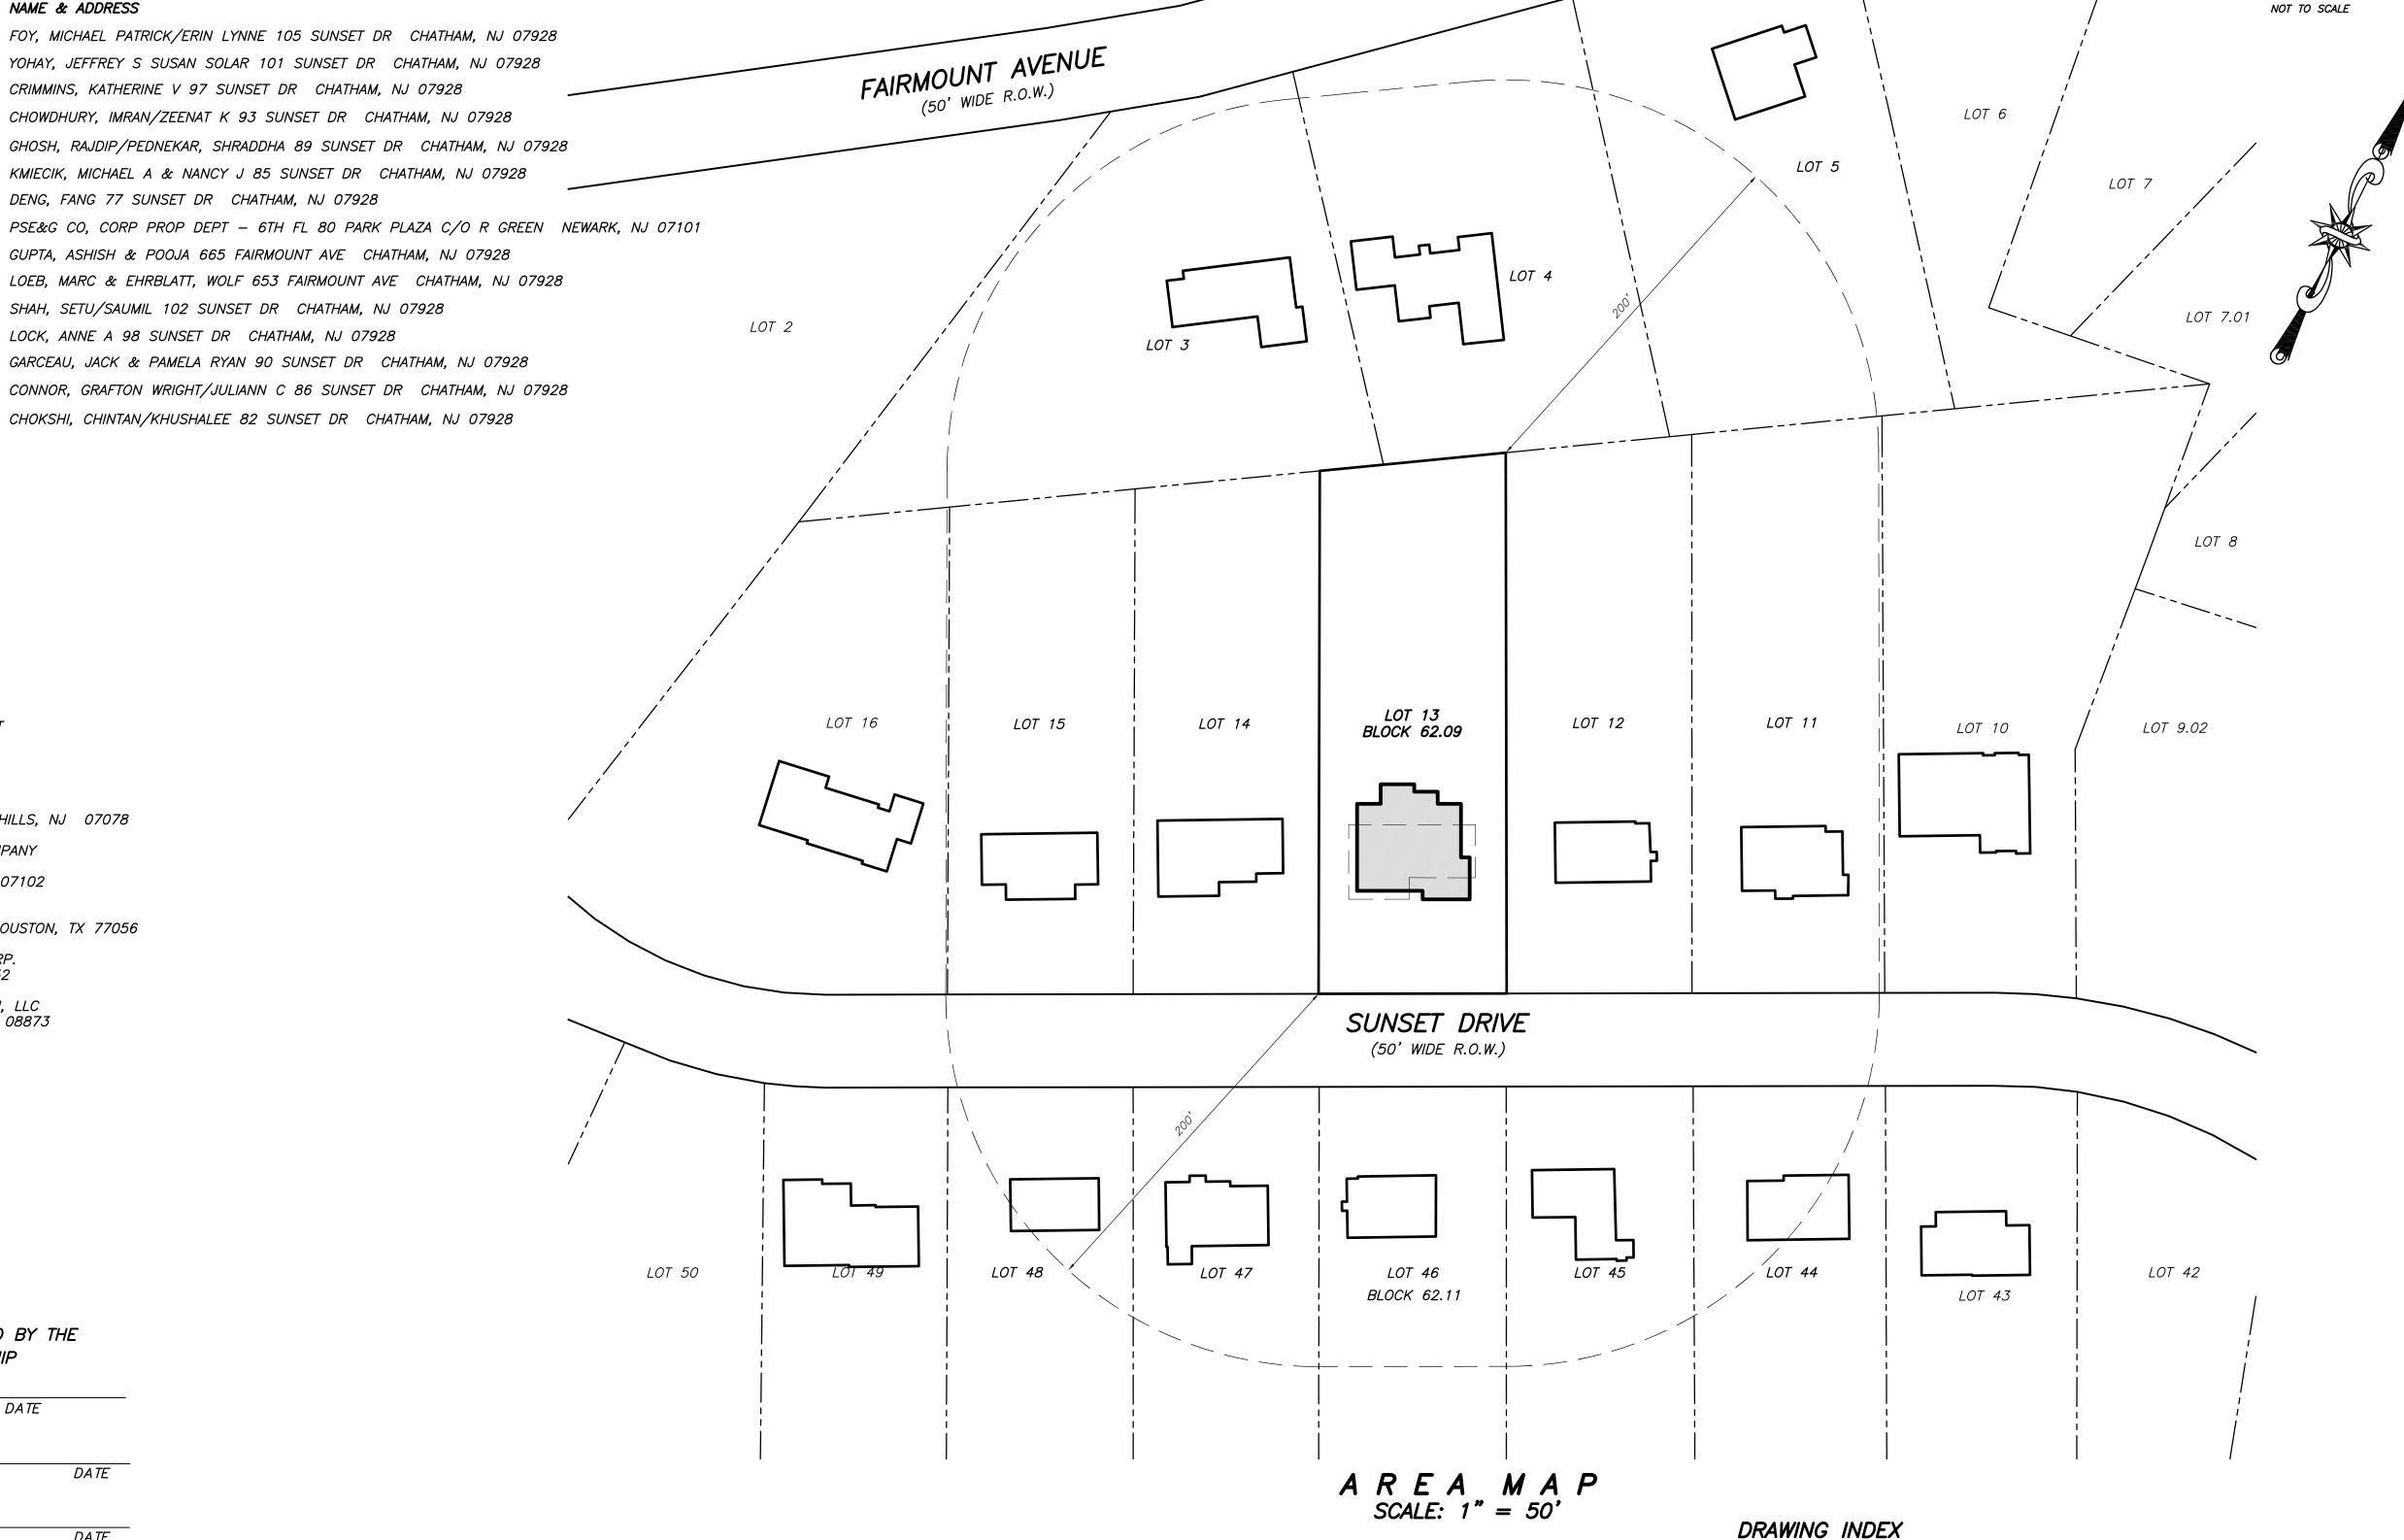

JCP&L CO. REAL ESTATE DEPARTMENT 300 MADISON AVENUE MORRISTOWN, NJ 07962

NEW JERSEY-AMERICAN WATER CO., ATTN: PAUL HARTELIUS 167 J.F. KENNEDY PARKWAY, SHORT HILLS, NJ 07078

TOWNSHIP OF CHATHAM, MORRIS COUNTY NEW JERSEY

LOCATION

62.09 10

62.09 11

62.09 12

62.09 13

62.09 15

62.09 16

14

62.09

62.09

62.09

105 SUNSET DR

101 SUNSET DR

97 SUNSET DR

93 SUNSET DR

89 SUNSET DR

85 SUNSET DR

77 SUNSET DR

661 FAIRMOUNT AVE

665 FAIRMOUNT AVE

653 FAIRMOUNT AVE

102 SUNSET DR

98 SUNSET DR

90 SUNSET DR

86 SUNSET DR

82 SUNSET DR

BASED ON A CERTIFIED LIST PREPARED BY THE TOWNSHIP OF TAX CLERK DATED JUNE 14, 2023.

PROPERTY OWNERS WITHIN 200 FT. OF SUBJECT PROPERTY

YOHAY, JEFFREY S SUSAN SOLAR 101 SUNSET DR CHATHAM, NJ 07928

CHOWDHURY, IMRAN/ZEENAT K 93 SUNSET DR CHATHAM, NJ 07928

KMIECIK, MICHAEL A & NANCY J 85 SUNSET DR CHATHAM, NJ 07928

GUPTA, ASHISH & POOJA 665 FAIRMOUNT AVE CHATHAM, NJ 07928

GARCEAU, JACK & PAMELA RYAN 90 SUNSET DR CHATHAM, NJ 07928

CHOKSHI, CHINTAN/KHUSHALEE 82 SUNSET DR CHATHAM, NJ 07928

SHAH, SETU/SAUMIL 102 SUNSET DR CHATHAM, NJ 07928

LOCK, ANNE A 98 SUNSET DR CHATHAM, NJ 07928

CRIMMINS, KATHERINE V 97 SUNSET DR CHATHAM, NJ 07928

DENG, FANG 77 SUNSET DR CHATHAM, NJ 07928

NAME & ADDRESS

PUBLIC SERVICE ELECTRIC &GAS COMPANY MANAGER -CORPORATE PROPERTIES 80 PARK PLAZA, T6B, NEWARK, NJ 07102

TEXAS EASTERN TRANSMISSION CORP. 5400 WESTHEIMER CT., SUITE 692, HOUSTON, TX 77056 TRANSCONTINENTAL GAS PIPELINE CORP.

P.O. BOX 1396, HOUSTON, TX 77252

COMCAST OF CENTRAL NEW JERSEY II. LLC 100 RANDOLPH ROAD, SOMERSET, NJ 08873

THIS PLAN HAS BEEN APPROVED BY THE ZONING BOARD OF THE TOWNSHIP

OF CHATHAM ON

DATE CHAIRMAN

DATE

DATE SECRETARY

DATE TOWN ENGINEER

OWNER/APPLICANT IMRAN CHOWDHURY 93 SUNSET DRIVE

CHATHAM, NJ 07928

ATTORNEY NICOLE MAGDZIAK, ESQ. DAY PITNEY, LLP 1 JEFFERSON ROAD 908-233-6800

ARCHITECT GREG RALPH, RA, AIA, NCARB GRA DESIGN STUDIO 1924 ROUTE 22 EAST PARSIPPANY, N.J. 07054 BOUND BROOK, NJ 08805 *908–731–1626*

CIVIL ENGINEERS & SURVEYORS RYAN L. SMITH, PE&LS YANNACCONE, VILLA & ALDRICH, LLC 460 MAIN STREET, P.O. BOX 459 CHESTER, NJ 07930

908-879-6640

1 of 5 TITLE SHEET
2 of 5 LOT DEVELOPMENT PLAN 3 of 5 EX. CONDITIONS, DEMOLITION, TREE REMOVAL, STEEP SLOPES AND S.E.S.C. PLAN 4 of 5 DETAIL SHEET 1 5 of 5 DETAIL SHEET 2

SHEET No. | SHEET TITLE

DRAWN BY: DATE:

CHOWDHURY

PROPERTY

93 SUNSET DRIVE LOT 13 ~ BLOCK 62.09 TOWNSHIP OF CHATHAM MORRIS COUNTY, NEW JERSEY

TITLE SHEET

JULY 7, 2023 JPWCHECKED BY: SCALE: AS SHOWN

W.O. 222096 F.B. 492/138


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PROJECT TITLE :

SHEET TITLE :

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SHEET 1 OF 5



4" CURB FACE OR MEET EXISTING FACE HEIGHT

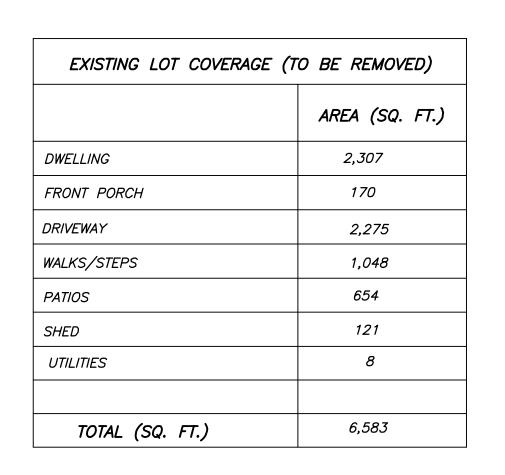TRANSITION FROM FULL CURB HEIGHT

TO 1 INCH CURB HEIGHT


PROPOSED LOT COVERAGE		
	AREA (SQ. FT.)	
DWELLING	3,071 (2)	
DRIVEWAY	1,658	
WALKS/STEPS	219	
PATIO	968	
AC/GEN	24	
TOTAL	5,940	


NET DECREASE IN LOT COVERAGE COVERAGE TO BE ADDED 5,940 SQ. FT. COVERAGE TO BE REMOVED - 6.583 SQ. FT. = 643 SQ. FT.

- (1) AREAS EXCLUDED IN PRINCIPAL BUILDING COVERAGE CALCULATIONS: ROOFLESS LANDINGS, STAIRS AND CHIMNEYS.
- (2) LOT COVERAGE FOR THE DWELLING INCLUDES ROOFLESS LANDINGS, STAIRS AND CHIMNEYS

TOTAL PROPOSED LOT COVERAGE

6,583 SQ. FT. EXISTING COVERAGE + 643 SQ. FT. NET DECREASE = 5,940 SQ. FT.

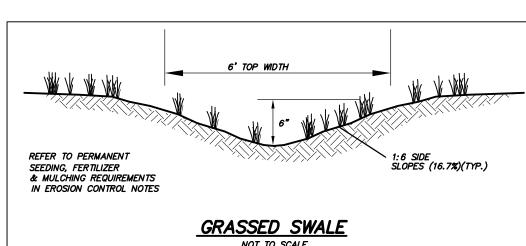

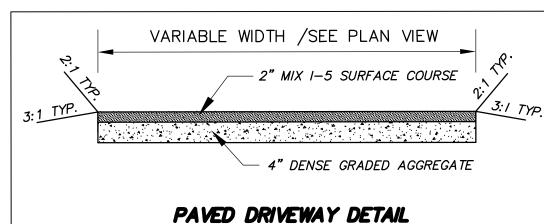

2' MINIMUM ?" NJDOT MIX I—5 SURFACE COURSE

NOT TO SCALE

- 4" NJDOT MIX I-2 STABILIZED BASE - 6" DENSE GRADED AGGREGATE ROADWAY RECONSTRUCTION DETAIL

NOT TO SCALE

NEW DRIVEWAY TO MEET EXISTING PAVEMENT AT GRADE. INSTALL DESPRESSED CURB ALONG EDGE OF EXISTING ROAD PAVEMENT. A ROAD OPENING PERMIT FROM RIGHT-OF-WAY. A MINIMUM 2' WIDE AREA OF ROADWAY RESTORATION IN ACCORDANCE WITH TOWNSHIP SPECIFICATIONS SHALL BE INSTALLED IN THE EVENT THAT THE EXISTING PAVEMENT IS DAMAGED AND NEEDS TO BE RECONSTRUCTED. (SEE ROADWAY RECONSTRUCTION DETAIL)

PRIOR TO CONSTRUCTION. RE-USE EXISTING CONNECTIONS WHEREVER POSSIBLE. CONNECTION TO EXISTING UTILITY TO BE MADE BEHIND THE RIGHT-OF-WAY LINE TO KEEP DISTURBANCE OUTSIDE OF THE RIGHT-OF-WAY. MODIFICATIONS WITHIN THE RIGHT-OF-WAY WILL

REQUIRE A ROAD OPENING PERMIT PRIOR TO DISTURBANCE.

ZONE REQUIREMENTS

PROPERTY IS LOCATED IN THE R-3 ZONE - ONE FAMILY RESIDENCE DISTRICT

ORDINANCE ITEM REQUIRED PROPOSED MIN. LOT AREA 20,000 SQ.FT. = 0.459 ACRES 27,878 SQ.FT. = 0.640 ACRES MIN.LOT WIDTH (STREET LINE) 90 FT. 100.00 FT. 100 FT. MIN.LOT WIDTH (SETBACK LINE) 100.00 FT. MIN. FRONT YARD 50 FT. 50.5 FT. MIN. SIDE YARD 15 FT. 19.8 FT. SIDE YARD COMBINED 30.0 FT.(2) 39.6 FT. MIN. REAR YARD 50 FT. 162.4 FT. 26.3 FT. (3) 35 FT./2-1/2 STORY MAX. BUILDING HEIGHT MAX. PRINCIPAL BUILDING COVERAGE *3,072.7 SQ.FT. (4) 3,071 SQ.FT.* MAX. LOT COVERAGE 7,575.6 SQ.FT. (5) 5,940 SQ.FT. (6) MAX. BUILDING WIDTH 70 FT. 60.4 FT.

(1) IN ACCORDANCE WITH CHATHAM TOWNSHIP ORDINANCE 30-96.14e, CHIMNEYS MAY PROJECT NOT MORE THAN 3 FEET INTO ANY REQUIRED SIDE YARD. (2) THE SIDE YARDS COMBINED SHALL BE AT LEAST 30% OF THE AVERAGE LOT WIDTH FOR SIDE YARD DETERMINATION AS DEFINED IN ARTICLE 2: AVERAGE LOT WIDTH FOR SIDE YARD DETERMINATION SHALL MEAN THE AVERAGE OF THE LENGTHS OF THE FRONT AND REAR YARD LINES MEASURED AT THE BUILDING. THE FRONT YARD LINE SHALL BE MEASURED FROM SIDE LINE TO SIDE LINE BY THE SHORTEST DISTANCES, PASSING THROUGH THE POINT OF THE BUILDING NEAREST THE STREET, THE REAR YARD LINE SHALL BE MEASURED FROM SIDE LINE TO SIDE LINE BY THE SHORTEST DISTANCE PASSING THROUGH THE POINT OF THE BUILDING FURTHEST FROM THE STREET:

REAR YARD LINE = 100.00' AVERAGE LOT WIDTH = (100.00 + 100.00) / 2 = 100.00COMBINED SIDE YARD = $30\% \times 100.00 = 30.00 \text{ FT}$.

(3) SEE BUILDING HEIGHT DETAIL ON SHEET 5

FRONT YARD LINE = 100.00'

(4) MAXIMUM BUILDING COVERAGE IS 2,000 SQ. FT. PLUS 6% OF LOT AREA GREATER THAN 10,000 SQ. FT. MAXIMUM COVERAGE = 2,000 SQ. FT. + 6% X (27,878 - 10,000) = 3,072.7 SQ. FT.

(5) MAXIMUM LOT COVERAGE IS 4,000 SQ. FT. PLUS 20% OF LOT AREA GREATER THAN 10,000 SQ. FT. MAXIMUM LOT COVERAGE = 4,000 SQ. FT. + 20% X (27,878 - 10,000) = 7,575.6 SQ. FT.

(6) SEE LOT COVERAGE TABLE

1/2" MAX. 5-1/2"MIN.

—FINISHED PAVEMENT—

STEEP SLOPE VARIANCE REQUIRED: SEE SHEET 3

GENERAL NOTES :

IMRAN CHOWDHURY 93 SUNSET DRIVE 1. OWNER/APPLICANT: CHATHAM, NJ 07928

LOT AREA = 20,027 SQ.FT. = 0.460 ACRES TOTAL DISTURBANCE = 24,261 SQ. FT. or 0.557 AC. DECREASE IN IMPROVED LOT COVERAGE = 643 SQ. FT.

THE BURYING OF BRUSH, STUMPS, TREES OR ANY CONSTRUCTION RELATED MATERIALS IS PROHIBITED. ALL MATERIAL (FILL, TOPSOIL, DEBRIS, ETC.) IN EXCESS OF THAT WHICH WILL BE USED FOR THE APPROVED LOT GRADING MUST BE REMOVED FROM THE SITE AND SHALL ONLY BE DISPOSED OF AT AN APPROVED AND PERMITTED SITE. DOCUMENTATION OF APPROVED DISPOSAL MUST BE PROVIDED UPON REQUEST. TEMPORARY STOCKPILES OF MATERIALS TO BE USED ON-SITE SHALL MUST BE ENCIRCLED BY SILT FENCING.

4. ALL ON SITE GRADING NOT TO EXCEED 3:1 SLOPES.

HEIGHT OF STRUCTURE SHALL MEAN THE VERTICAL DISTANCE MEASURED FROM THE AVERAGE GROUND ELEVATION, AS DETERMINED BY THE AVERAGE OF THE LOWEST GROUND ELEVATION AND THE HIGHEST GROUND ELEVATION WITHIN FIFTEEN (15) FEET OF THE FOUNDATION, I.E. THE UNDERLYING BASE, SUBSTRUCTURE, OR SUPPORT OF A BUILDING, TO A HORIZONTAL PLANE PROJECTED FROM THE HIGHEST POINT OF THE ROOF, USING PREDEVELOPMENT GRADES IF FILL HAS BEEN ADDED AND POST-DEVELOPMENT GRADES IF FILL HAS BEEN REMOVED. SEE SPOT ELEVATION ON SHEET # 2 FOR ADDITIONAL DETAIL.

6. USE 6" P.V.C. HORIZONTAL STORM DRAINS @1.0% MIN. AROUND THE PERIMETER OF DWELLING, AS PER NATIONAL PLUMBING CODE. ALL GUTTER DRAIN DOWNSPOUTS ARE TO BE INSTALLED WITH SCREENING AT THE TOP OF THE DOWNSPOUT.

ALL UTILITIES ARE TO BE INSTALLED UNDERGROUND. AFTER THE BACKFILLING OF TRENCHES FOR THE UTILITIES. THESE AREAS ARE TO BE STABILIZED IN ACCORDANCE WITH THE SPECIFICATIONS

IMMEDIATELY AFTER FINE GRADING, ALL AREAS SHALL BE LIMED, FERTILIZED AND SEEDED.

DISTURB AS LITTLE AREA AS POSSIBLE DURING EXCAVATION. THE CONTRACTOR MUST FOLLOW THE PROPOSED LIMIT OF DISTURBANCE AS SHOWN ON THE PLAN.

TREES SHALL BE MARKED IN THE FIELD TO SATISFY THE TREE PROTECTION REGULATIONS, AS NECESSARY. REPLACEMENT TREES SHALL BE LOCATED IN ACCORDANCE WITH THE THE DIRECTIVE OF THE CHATHAM TOWNSHIP TREE PRESERVATION COMMITTEE.

11. LOT BOUNDARY AND DIMENSIONS TAKEN FROM A SURVEY PREPARED BY THIS FIRM DATED 11/1/18 SIGNED BY CHRISTOPHER J. ALDRICH, NJPLS LIC. NO. 34478.

TOPOGRAPHY WAS FIELD COLLECTED BY THIS FIRM ON 11/11/22 UNDER THE SUPERVISION OF CHRISTOPHER J. ALDRICH, NJPLS LIC. NO. 34478.

13. ARCHITECTURAL PLANS FOR THIS PROJECT PREPARED BY GRA DESIGN STUDIO. SEE THOSE PLANS FOR CROSS REFERENCING.

14. CARE SHOULD BE TAKEN TO INSURE POSITIVE SURFACE DRAINAGE AWAY FROM THE FOUNDATION.

15. THE EXISTING & PROPOSED DWELLING ARE SERVED BY PUBLIC WATER, PUBLIC SEWAGE AND GAS.

16. PRIOR TO REMOVAL OF EXISTING HOUSE, A DEMOLITION PERMIT MUST BE OBTAINED FROM CHATHAM TOWNSHIP CONSTRUCTION OFFICIAL.

17. ALL SESC MEASURES MUST BE INSTALLED PRIOR TO ANY DISTURBANCE AND MAINTAINED THROUGHOUT CONSTRUCTION AS PER THE APPROVED LOT GRADING PLAN. ALL DISTURBED AREAS SHALL BE STABILIZED (TEMPORARILY AND PERMANENTLY) IN CONFORMANCE WITH THE SOIL EROSION AND SEDIMENT CONTROL NOTES PROVIDED ON SHEET 2.

18. SILT FENCING SHOULD BE INSTALLED SO AS TO NOT DAMAGE THE ROOT STRUCTURE OF ANY EXISTING TREES TO REMAIN.

19. THE REQUIRED FOUNDATION LOCATION SURVEY SHOULD INCLUDE BOTH THE TOP OF BLOCK ELEVATION AND THE PROPOSED FIRST FLOOR ELEVATION. PER ORDINANCE No. 30-96.20(c), UPON CONSTRUCTION OF THE FOUNDATION, PRIOR TO FRAMING OR FURTHER CONSTRUCTION, THE APPLICANT SHALL SUBMIT AN "AS-BUILT" FOUNDATION SURVEY CONFIRMING THAT THE FIRST FLOOR ELEVATION OF THE BUILDING IS WITHIN EIGHTEEN INCHES OF THE FIRST FLOOR ELEVATION AS SHOWN ON THE APPROVED GRADING PLAN. FOLLOWING APPROVAL BY THE TOWNSHIP ENGINEER OF THE "AS-BUILT" FOUNDATION SURVEY, AND UPON FRAMING TO THE RIDGE OF THE ROOF, BUT PRIOR TO ANY SHEATHING OR OTHER CONSTRUCTION, "AS-BUILT" ELEVATION DRAWINGS OF THE BUILDING SHALL BE

20. NO FILL MAY BE PLACED WITHIN 5 FEET OF ANY PROPERTY LINES.

21. PRIOR TO THE INSTALLATION OF THE DRYWELLS, THE DESIGN ENGINEER MUST FIELD INSPECT THE EXCAVATION. THE DESIGN ENGINEER MUST CERTIFY THAT THERE IS TWO FEET OF CLEARANCE BELOW THE STONE BEDDING TO SEASONAL GROUNDWATER OR LOW PERMEABLE SOIL. THIS CERTIFICATION MUST BE SUBMITTED TO AND APPROVED BY THE TOWNSHIP ENGINEER PRIOR TO THE INSTALLATION OF THE DRYWELL

22. THE DESIGN ENGINEER MUST CERTIFY, BASED ON FIELD INSPECTIONS, THAT THE STORMWATER MANAGEMENT SYSTEM IS INSTALLED IN CONFORMANCE WITH THE DESIGN INCLUDED IN THE APPROVED LOT GRADING PLAN AS AMENDED.

23. THE PROPERTY LINES AND PROPOSED LIMIT OF DISTURBANCE SHALL BE CLEARLY STAKED PRIOR TO ANY DISTURBANCE.

24. UPON COMPLETION OF THE ROOF OF THE HOUSE, GUTTERS AND LEADERS SHALL BE INSTALLED AND CONNECTED TO THE DRYWELLS AS SOON AS POSSIBLE AFTER CERTIFICATION THAT THE DRYWELLS HAVE BEEN CONSTRUCTED IN ACCORDANCE WITH THE APPROVED PLAN.

25. EXISTING UNDERGROUND UTILITY INFORMATION SHOWN HEREON IS APPROXIMATE AND IS NOT GUARANTEED AS TO ACCURACY OR COMPLETENESS. THE CONTRACTOR SHALL VERIFY ALL INFORMATION PRIOR TO BEGINNING ANY CONSTRUCTION. THE CONTRACTOR SHALL CALL UNDERGROUND UTILITIES 1-800-272-1000 FOR MARKOUT PRIOR TO ANY EXCAVATION. WHERE EXISTING UNDERGROUND UTILITIES ARE TO BE CROSSED BY PROPOSED CONSTRUCTION, TEST PITS SHALL BE DUG BY THE CONTRACTOR PRIOR TO CONSTRUCTION TO ASCERTAIN EXISTING LOCATIONS, ELEVATIONS, MATERIALS AND SIZES. TEST PIT INFORMATION SHALL BE GIVEN TO THE ENGINEER PRIOR TO CONSTRUCTION TO PERMIT ADJUSTMENTS AS REQUIRED TO AVOID CONFLICTS.

26. ACCORDING TO THE USDA NRCS WEB SOIL SURVEY, THE SOILS ON THE SUBJECT PROPERTY ARE:

NehDb NESHAMINY SILT LOAM, 12 TO 18% SLOPES, VERY STONY, HYDROLOGIC SOIL GROUP B

27. THERE ARE NO WETLANDS WITHIN 150 FEET OF THE SUBJECT PROPERTY.

ZONING ORDINANCE FOR MAXIMUM LOT COVERAGE.

28. THERE ARE NO CATEGORY ONE WATERS WITHIN 300 FEET OF THE SUBJECT PROPERTY. 29. NO PORTION OF THE DRIVEWAY IS FURTHER THAN 150 FEET FROM THE RIGHT—OF—WAY LINE.

30. A ROAD OPENING PERMIT IS REQUIRED FOR DISTURBANCE TO TAKE PLACE IN THE SUNSET DRIVE RIGHT-OF-WAY.

31. THE LOCATION AND ELEVATION OF THE EXISTING SANITARY SEWER MAIN MUST BE CONFIRMED BY THE CONTRACTOR PRIOR TO CONSTRUCTION OF THE SANITARY LATERAL AND DRYWELLS. NOTIFY ENGINEER OF ANY CONFLICTS.

32. THE DRYWELL SYSTEM HAS BEEN DESIGNED TO ACCOMMODATE AN INCREASE OF PATIO/HARDSCAPES UP TO THE ALLOWABLE

RYAN L. SMITH NEW JERSEY LICENSED PROFESSIONAL ENGINEER AND LAND SURVEYOR No. 42575 NOT VALID WITHOUT SIGNATURE AND RAISED SEA DATE REVISION

& Land Surveyors

YANNACCONE

& ALDRICH, LLC

460 MAIN STREET, P.O. BOX 459

CHESTER, NEW JERSEY 07930

PHONE: 908-879-6646

FAX: 908-879-8591

N.J. STATE BOARD FOR P.E. & P.L.S. CERTIFICATE

OF AUTHORIZATION No. 24GA27934500

PROJECT TITLE: CHOWDHURY **PROPERTY**

LOT 13 ~ BLOCK 62.09 TOWNSHIP OF CHATHAM MORRIS COUNTY, NEW JERSEY

93 SUNSET DRIVE

SHEET TITLE :


LOT DEVELOPMENT **PLAN**

DRAWN BY:	DATE:
RLH	JULY 7, 2023
CHECKED BY:	SCALE:
RL5	1" = 20'
W.O. 222096	


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SHEET **2** OF **5**



GRANITE BLOCK— 12" TO 14" HIGH

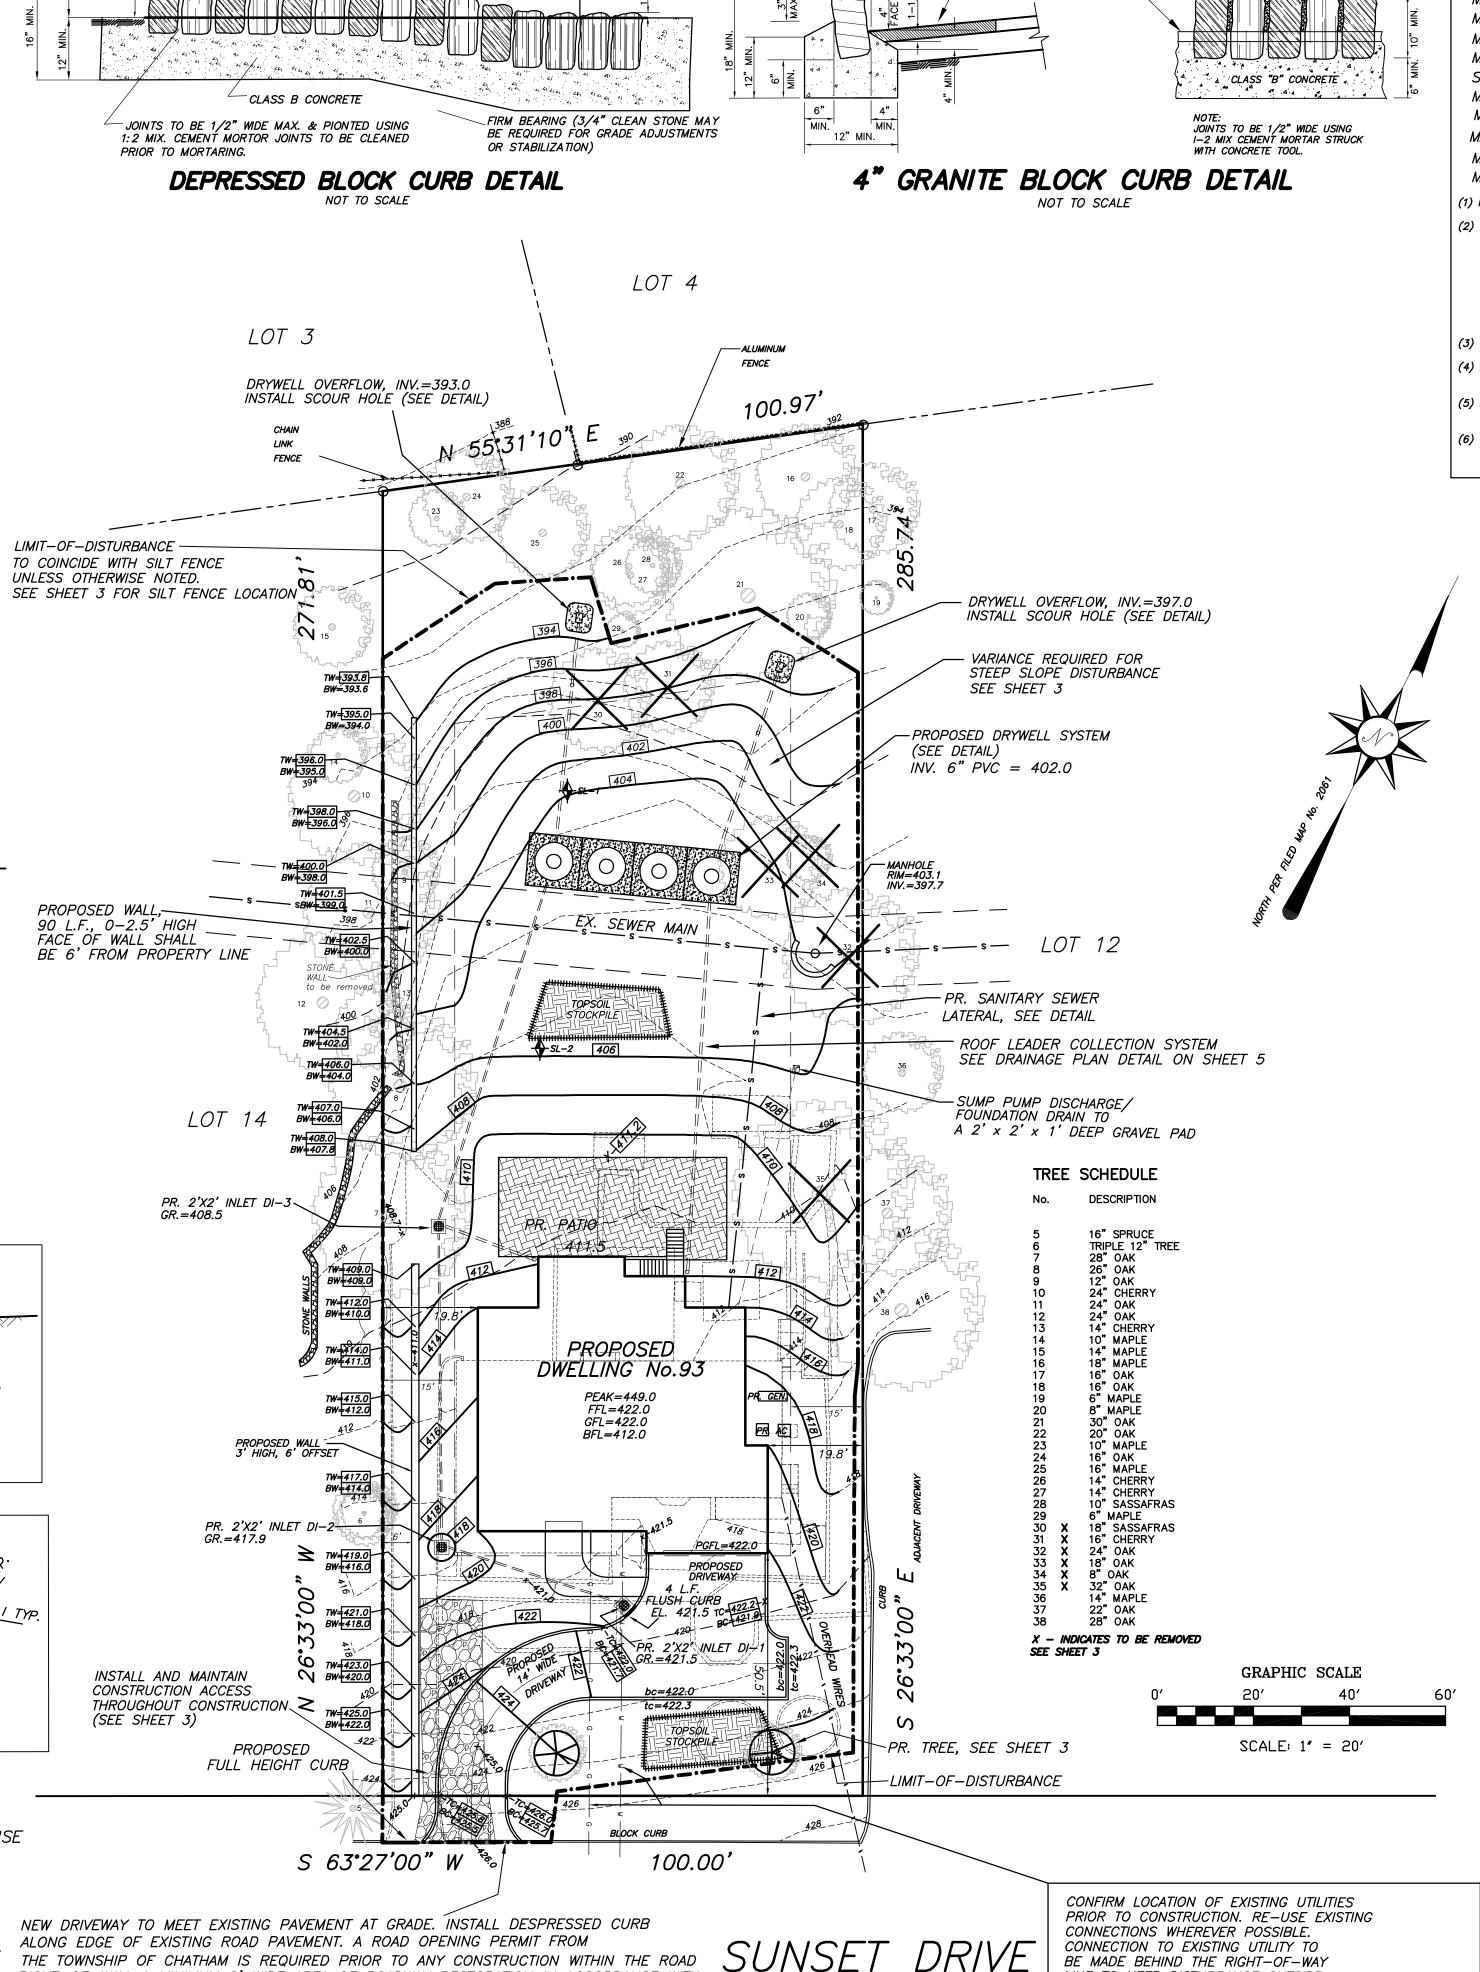

CHATHAM TOWNSHIP - SOIL EROSION AND SEDIMENT CONTROL NOTES

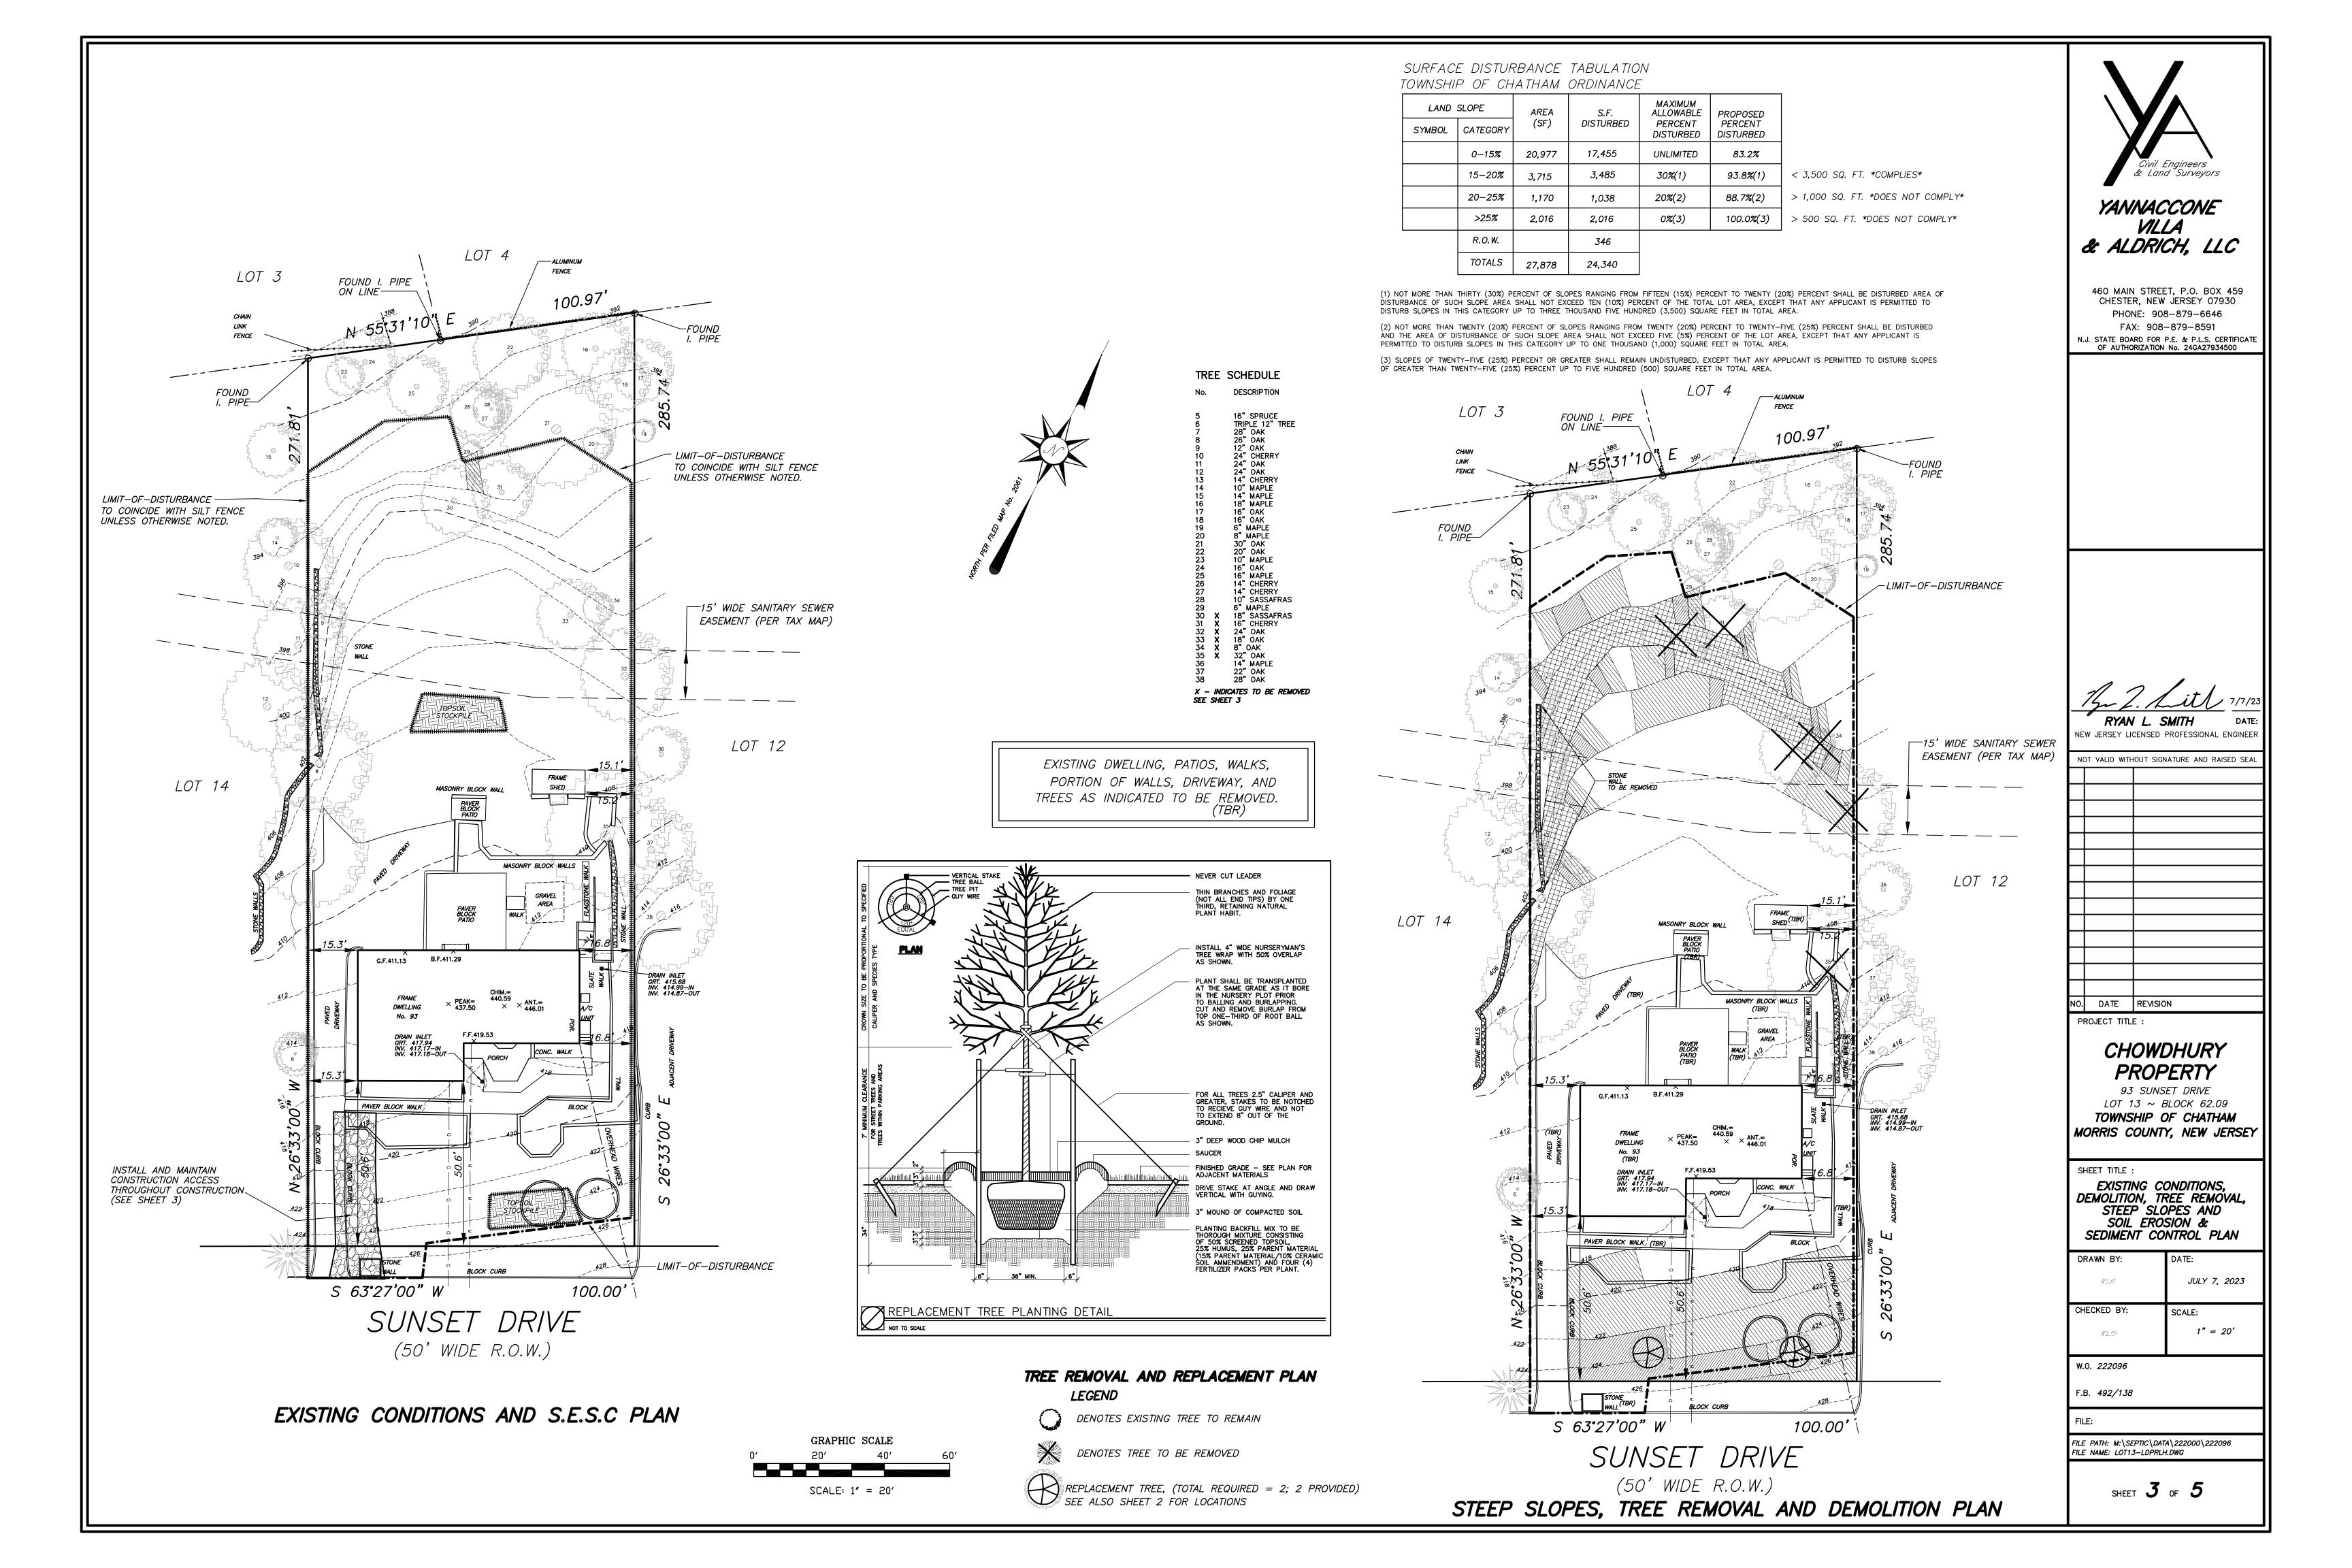- 1. ALL SOIL EROSION AND SEDIMENT CONTROL PRACTICES ON THIS PLAN WILL BE CONSTRUCTED IN ACCORDANCE WITH THE "NEW JERSEY STANDARDS FOR SOIL EROSION AND SEDIMENT CONTROL," (REVISED 1999) AND WILL BE IN PLACE PRIOR TO ANY SOIL DISTURBANCE OR IN THEIR PROPER SEQUENCE AND MAINTAINED UNTIL PERMANENT PROTECTION IS ESTABLISHED.
- 2. CHATHAM TOWNSHIP WILL BE NOTIFIED 72 HOURS PRIOR TO ANY LAND DISTURBANCE.
- 3. DURING AND AFTER CONSTRUCTION, THE OWNER WILL BE RESPONSIBLE FOR THE MAINTENANCE AND UPKEEP OF THE DRAINAGE STRUCTURES, VEGETATIVE COVER, ANY OTHER MEASURES DEEMED APPROPRIATE BY THE TOWNSHIP.
- 4. A CRUSHED STONE VEHICLE WHEEL CLEANING BLANKET WILL BE INSTALLED WHEREVER A CONSTRUCTION ACCESS ROAD INTERSECTS ANY PAVED ROADWAY. SAID BLANKET WILL BE COMPOSED OF 2 1/2" CRUSHED STONE, WILL BE AT LEAST 50 FEET LONG AND THE WIDTH OF THE EXIT ROADWAY OR DRIVEWAY, AND WILL BE PROPERLY MAINTAINED.
- 5. ALL PAVED ROADWAYS MUST BE KEPT CLEAN AT ALL TIMES.
- 6. ALL NEW ROADWAYS AND DRIVEWAYS WILL BE TREATED WITH A SUITABLE SUBBASE UPON ESTABLISHMENT OF FINAL GRADE ELEVATIONS.
- 7. DISTURBED AREAS SHALL BE MAINTAINED IN A ROUGH GRADED CONDITION AND TEMPORALLY SEEDED AND MULCHED UNTIL PROPER WEATHER CONDITIONS EXIST FOR THE ESTABLISHMENT OF PERMANENT VEGETATIVE COVER
- 8. ALL SOIL STOCKPILED FOR A PERIOD OF GREATER THAN 30 DAYS WILL BE TEMPORARILY SEEDED AND MULCHED.
- 9. STOCKPILES SHALL NOT BE LOCATED WITHIN 50 FEET OF FLOODPLAIN, SLOPE, DRAINAGE FACILITY, OR ROADWAY. ALL STOCKPILE BASES SHALL BE PROTECTED BY HAY BALE BARRIER OR SEDIMENT FENCE.
- 10. IMMEDIATELY FOLLOWING INITIAL DISTURBANCE OR ROUGH GRADING, ALL CRITICAL AREAS SUBJECT TO EROSION WILL RECEIVE A TEMPORARY SEEDING IN COMBINATION WITH THE STRAW MULCH OR SUITABLE EQUAL, AT A 2 TON/ACRE RATIO RATE, ACCORDING TO STATE STANDARDS.
- 11. TEMPORARY STABILIZATION— ANY DISTURBED AREA THAT WILL BE LEFT EXPOSED FOR MORE THAN THIRTY DAYS AND NOT SUBJECT TO CONSTRUCTION ACTIVITIES SHALL IMMEDIATELY BE STABILIZED UPON DISTURBANCE BY APPLYING THE FOLLOWING:
- a) GROUND LIMESTONE AT A RATE OF 90 POUNDS PER 1,000 SQUARE FEET.
- b) FERTILIZER AT A RATE OF 14 POUNDS PER 1,000 SQUARE FEET USING A 10-20-10 ANALYSIS OR AN EQUIVALENT WORKED INTO THE SOIL A MINIMUM OF 4 INCHES.
- c) SEED SHALL BE ANNUAL RYEGRASS APPLIED AT NOT LESS THAN 1 POUND PER 1,000 SQUARE FEET.
- d) MULCH ALL NEWLY SEEDED AREA WITH UNROTTED SALT HAY OR SMALL GRAIN STRAW AT A RATE OF 90 POUNDS PER 1,000 SQUARE FEET ACCORDING TO THE N.J. STANDARD. MULCH SHALL NOT BE GROUND INTO SHORT PIECES IN NO CASE SHALL MORE THAN 5 DAYS ELAPSE BETWEEN SEEDING AND MULCHING.
- e) MULCH SHALL BE ANCHORED WITH A LIQUID MULCH BINDER APPLIED AT A RATE OF 1 GAL./1,000 S.F. OR BY APPROVED METHODS (I.E. PEG AND TWINE, MULCH NETTING.)
- 12. BETWEEN OCTOBER 1 AND MARCH 1 AND WHEN THE SEASON PROHIBITS TEMPORARY SEEDING OR WHEN DISTURBED AREAS ARE SCHEDULED FOR IMMEDIATE LANDSCAPING, APPLYING THE AFOREMENTIONED ITEMS "d)" AND "e)" WILL BE ADEQUATE.
- 13. SEEDING DATES: THE FOLLOWING ARE RECOMMENDED SEEDING DATES FOR THE ESTABLISHMENT OF TEMPORARY OR PERMANENT VEGETATION.
- a) SPRING: (MARCH 1 MAY 15) b) FALL: (AUGUST 15 - OCTOBER 1)
- 14. PERMANENT VEGETATIVE COVER IS TO BE ESTABLISHED ON EXPOSED AREAS WITHIN 10 DAYS AFTER FINAL GRADING. MULCH IS TO BE USED FOR PROTECTION UNTIL FINAL VEGETATION IS ESTABLISHED.
- 15. PERMANENT SEEDING AND STABILIZATION TO BE IN ACCORDANCE WITH THE STANDARDS FOR VEGETATIVE COVER— ALL EXPOSED SURFACES WILL BE TREATED WITH 4 INCHES OF TOPSOIL PRIOR TO FINAL STABILIZATION AND THE FOLLOWING ITEMS APPLIED AT THE DESIGNATED RATES:
- a)LIME SHALL BE APPLIED AT 90 POUNDS PER 1,000 SQUARE FEET CONSISTING OF GROUND LIMESTONE INCORPORATED INTO THE TOP 4 INCHES OF TOPSOIL.
- b)FERTILIZER SHALL BE 14 POUNDS PER 1,000 SQUARE FEET 10-20-10

INCORPORATED INTO THE TOP 4 INCHES OF TOPSOIL.

- c) SEED SHALL BE 25 POUNDS PER ACRE OF KENTUCKY BLUEGRASS, 15 POUNDS PER ACRE OF RED FESCUE, SPREADING FESCUE AT 15 POUNDS PER ACRE, AND 10 POUNDS PER ACRE OF PERENNIAL RYEGRASS.
- d) IN SHADE AREAS INCREASE RED FESCUE 20 POUNDS PER ACRE AND DECREASE KENTUCKY BLUE GRASS 20 POUNDS PER ACRE.
- e) MULCH ALL NEWLY SEEDED AREA WITH UNROTTED SALT HAY OR SMALL GRAIN STAW AT A RATE OF 90 POUNDS PER 1,000 SQUARE FEET ACCORDING TO THE N.J. STANDARD. MULCH SHALL NOT BE GROUND INTO SHORT PIECES AND IN NO CASE SHALL MORE THAN 5 DAYS ELAPSE BETWEEN SEEDING AND MULCHING.
- f) MULCH SHALL BE ANCHORED WITH A LIQUID MULCH BINDER APPLIED AT A RATE OF 1 GAL./1,000 S.F. OR BY APPROVED METHODS (I.E. PEG AND TWINE, MULCH NETTING).
- 16. MAXIMUM SIDE SLOPES ALL EXPOSED SURFACES SHALL NOT EXCEED 3:1 UNLESS OTHERWISE APPROVED BY THE TOWNSHIP.
- 17. THE SITE SHALL, AT ALL TIMES, BE GRADED AND MAINTAINED SUCH THAT ALL STORM WATER RUNOFF IS DIVERTED TO SOIL EROSION AND SEDIMENT CONTROL FACILITIES.
- 18. ALL DEWATERING OPERATIONS MUST DISCHARGE DIRECTLY INTO A SEDIMENT FILTER AREA. THE SEDIMENT FILTER SHOULD BE COMPOSED OF A SUITABLE FILTER FABRIC FILTER.
- 19. ALL SEDIMENTATION STRUCTURES WILL BE INSPECTED AND MAINTAINED ON A REGULAR BASIS.
- 20. ALL STORM DRAIN INLETS SHALL BE PROTECTED WITH GRAVEL FILTERS TO PREVENT ENTRY OF SEDIMENT CARRIED BY RUNOFF WATER UNTIL VEGETATION AND/OR PAVING IS ESTABLISHED.

- 21. ALL STORM DRAIN OUTLETS WILL BE STABILIZED AS REQUIRED BEFORE THE DISCHARGE POINTS BECOME OPERATIONAL.
- 22. ALL TREES TO REMAIN AFTER CONSTRUCTION ARE TO BE PROTECTED WITH TREE PROTECTION DEVICES OR SEDIMENT BARRIERS.
- 23. THE TOWNSHIP MAY REQUEST ADDITIONAL MEASURES TO MINIMIZE ON OR OFF SITE EROSION PROBLEMS DURING CONSTRUCTION.

24. SEQUENCE OF CONSTRUCTION :

SEQUI	ENCE OF CONSTRUCTION :		
1.	INSTALL STABLIZED CONSTRUCTION ACCESS ON EXISTING DRIVEWAY.	1	DAY
2.	INSTALL SILT FENCE AND SOIL EROSION/SEDIMENT CONTROL MEASURES RAZE EXISTING IMPROVEMENTS. SEE DEMOLITION PLAN ON SHEET 2.	•	DAY WEEK
<i>3</i> .	CLEAR SITE, STRIP AND STOCKPILE SOIL.	1	DAY
4.	ROUGH GRADE. PROVIDE TEMPORARY STABILIZATION.	2	DAYS
<i>5</i> .	CONSTRUCT DWELLING, ROOF DRAINS, AND DRYWELL	4	MONTH
<i>6</i> .	CONSTRUCT DRIVEWAY	2	DAYS
<i>7</i> .	FINE GRADE.	2	DAYS
<i>8</i> .	GRADED AREAS SOIL DE-COMPACTION TESTING AND REMEDIATION.	2	DAYS
<i>9</i> .	INSTALL TOPSOIL, LANDSCAPING AND PERMANENT STABILIZATION	3	DAYS
10.	REMOVE TEMPORARY SILT FENCE, INLET PROTECTION AND OTHER SOIL EROSION CONTROLS ONLY AFTER DISTURBED AREAS HAVE BEEN STABLIZED.	1	DAY


25. A COPY OF THE SOIL EROSION AND SEDIMENT CONTROL PLAN MUST BE ON—SITE AT ALL TIMES AND MADE AVAILABLE TO A TOWNSHIP REPRESENTATIVE DURING INSPECTION.

DUST CONTROL NOTES

THE FOLLOWING METHODS SHOULD BE CONSIDERED FOR CONTROLLING DUST:

- 1. MULCH SEE STANDARD OF STABILIZATION WITH MULCHES ONLY (SE&SC IN NJ, #5, JULY 1999).
- 2. VEGETATIVE COVER SEE STANDARD FOR: TEMPORARY VEGETATIVE COVER (SE&SC IN NJ, #7, JULY 1999), AND PERMANENT VEGETATIVE COVER FOR SOIL STABILIZATION (SE&SC IN NJ, #4, JULY 1999) AND PERMANENT STABILIZATION WITH SOD (SE&SC IN NJ, #6, JULY 1999).
- 3. SPRAY—ON ADHESIVES ON MINERAL SOILS (NOT EFFECTIVE ON MUCK SOILS). KEEP TRAFFIC OFF THESE AREAS. SEE SE&SC IN NJ, #16, JULY 1999, FOR DUST CONTROL ADHESIVES.
- 4. TILLAGE TO ROUGHEN SURFACE AND BRING CLODS TO THE SURFACE. BEGIN PLOWING ON WINDWARD SIDE OF SITE BEFORE SOIL BLOWING STARTS. CHISEL—TYPE PLOWS SPACED ABOUT 12 INCHES APART, AND SPRING—TOOTHED HARROWS ARE EXAMPLES OF EQUIPMENT WHICH MAY PRODUCE THE DESIRED EFFECT.
- 5. SPRINKLING SITE IS SPRINKLED UNTIL THE SURFACE IS WET.
- 6. BARRIERS SOLID BOARD FENCES, SNOW FENCES, BURLAP FENCES, CRATE WALLS, BALES OF HAY AND SIMILAR MATERIAL CAN BE USED TO CONTROL AIR CURRENTS AND SOIL BLOWING.
- 7. CALCIUM CHLORIDE SHALL BE IN THE FORM OF LOOSE, DRY GRANULES OR FLAKES FINE ENOUGH TO FEED THROUGH COMMONLY USED SPREADERS AT A RATE THAT WILL KEEP SURFACE MOIST BUT NOT CAUSE POLLUTION OR PLANT DAMAGE. IF USED ON STEEPER SLOPES, THEN USE OTHER PRACTICES TO PREVENT WASHING INTO STREAMS, OR ACCUMULATION AROUND PLANTS.
- 8. STONE COVER SURFACE WITH CRUSHED STONE OR COARSE GRAVEL.

BRANCH BARK RIDGE FINAL CUT BRANCH COLLAR

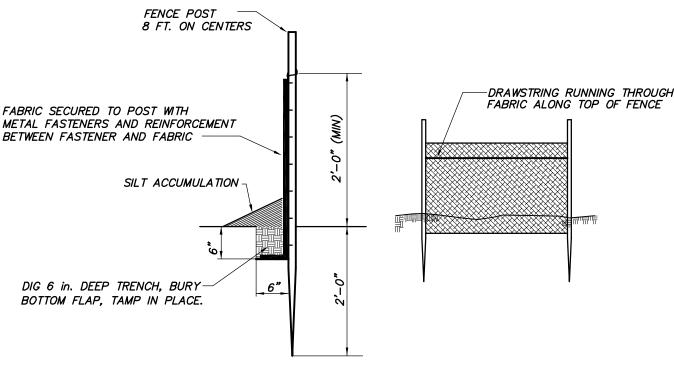



SILT FENCE DETAIL NOT TO SCALE

REF.: STANDARDS FOR SOIL EROSION AND SEDIMENT CONTROL IN NEW JERSEY, PAGE 25-4.


REQUIREMENTS FOR SILT FENCE:

- (1.) FENCE POSTS SHALL BE SPACED 8 FEET CENTER—TO—CENTER OR CLOSER. THEY SHALL EXTEND AT LEAST 2 FEET INTO THE GROUND AND EXTEND AT LEAST 2 FEET ABOVE GROUND. POSTS SHALL BE CONSTRUCTED OF HARDWOOD WITH A MINIMUM DIAMETER THICKNESS OF 1—1/2 INCHES.
- (2.) A METAL FENCE WITH 6 INCH OR SMALLER OPENINGS AND AT LEAST 2 FEET HIGH MAY BE UTILIZED. IT MUST BE FASTENED TO THE FENCE POSTS TO PROVIDE REINFORCEMENT AND SUPPORT TO THE GEOTEXTILE FABRIC WHERE SPACE FOR OTHER PRACTICES IS LIMITED AND HEAVY SEDIMENT LOADING IS EXPECTED.
- (3.) A GEOTEXTILE FABRIC, RECOMMENDED FOR SUCH USE BY THE MANUFACTURER, SHALL BE BURIED AT LEAST 6 INCHES DEEP IN THE GROUND. THE FABRIC SHALL EXTEND AT LEAST 2 FEET ABOVE THE GROUND. THE FABRIC MUST BE SECURELY FASTENED TO THE POSTS USING A SYSTEM CONSISTING OF METAL FASTENERS (NAILS OR STAPLES) AND A HIGH STRENGTH REINFORCEMENT MATERIAL (NYLON WEBBING, GROMMETS, WASHERS, ETC.). PLACED BETWEEN THE FASTENER AND THE GEOTEXTILE FABRIC. THE FASTENING SYSTEM SHALL RESIST TEARING AWAY FROM THE POST. THE FABRIC SHALL INCORPORATE A DRAWSTRING IN THE TOP PORTION OF THE FENCE.

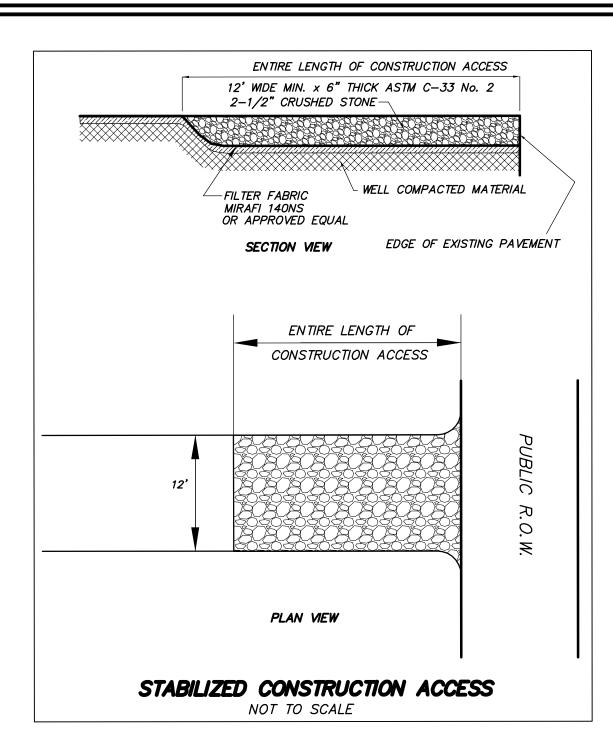

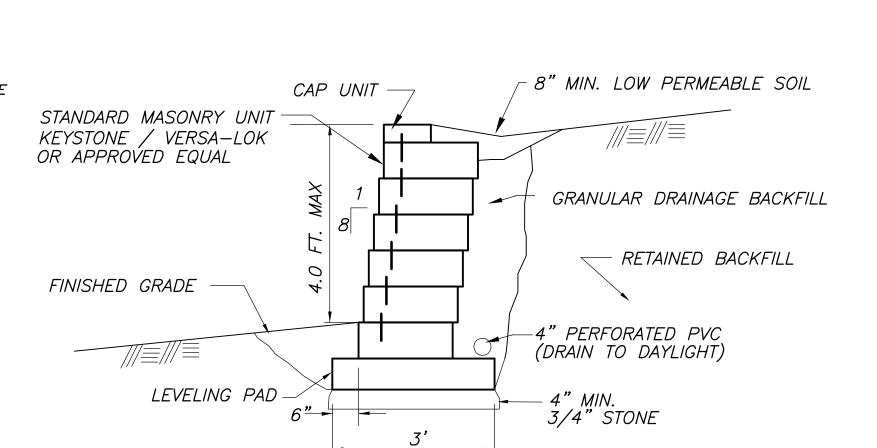

TYPICAL MASONRY RETAINING WALL (OR APPROVED EQUAL) STANDARD MASONRY UNIT - 1" SETBACK

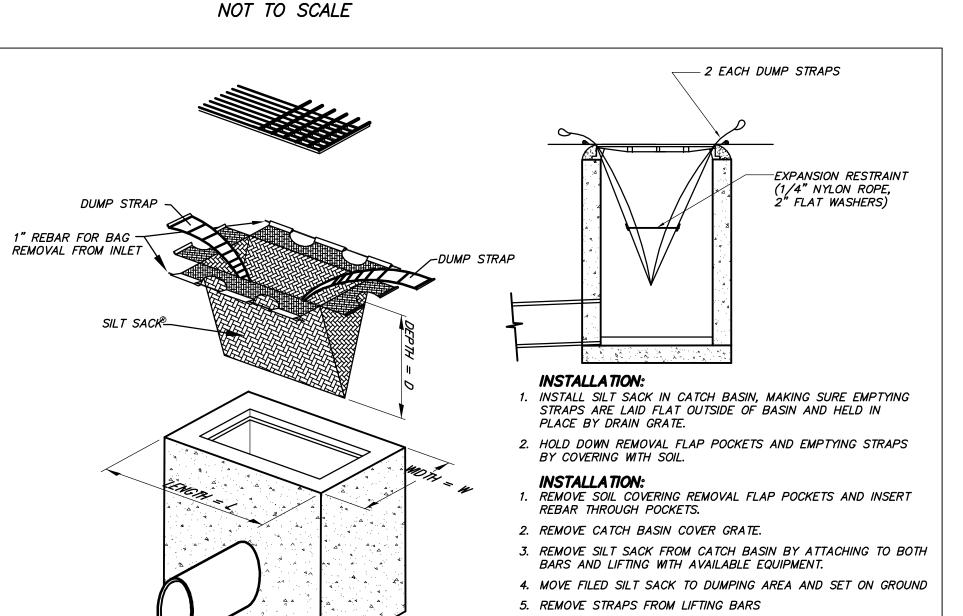


6. INSERT A LIFTING BAR THROUGH BOTH EMPTYING STRAPS
7. LIFT WITH AVAILABLE EQUIPMENT WITH EMPTYING STRAPS

DRYWELL GRATE SILT FILTERING SYSTEM

ACF ENVIRONMENTAL-2831 CARDWELL ROAD-RICHMOND, VIRGINIA 23234-(800) 448-3636


CATALOG NUMBER - SILTO2X04

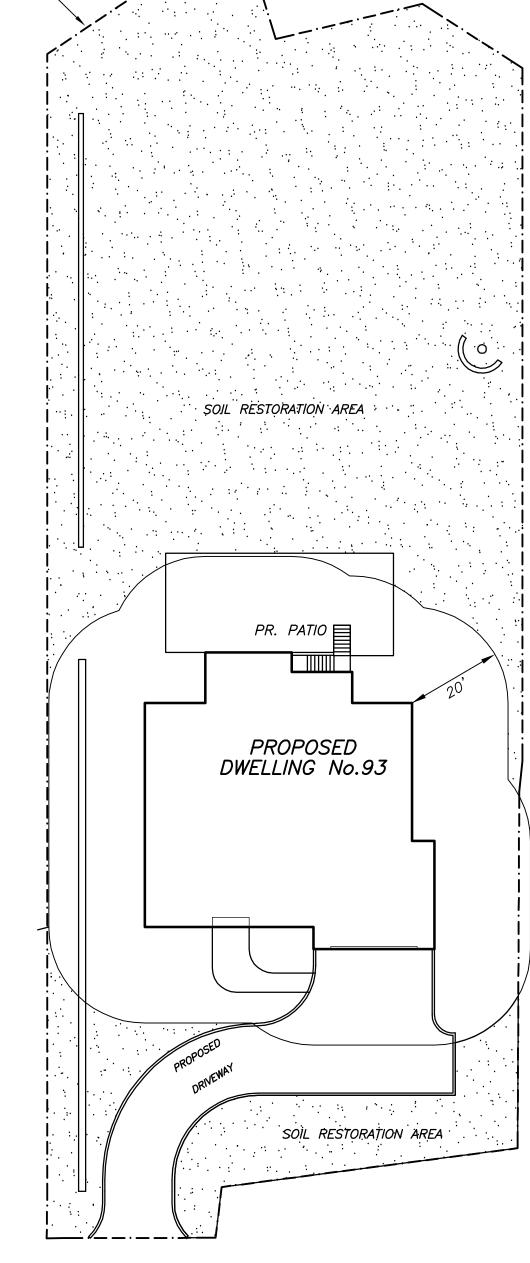

LIMIT-OF-DISTURBANCE

SOIL DE-COMPACTION DETAIL
SCALE: 1" = 20'

TOTAL RESTORATION AREA = 13,919 SF = 0.320 AC. TOTAL DISTURBANCE = 24,261 SQ. FT. or 0.557 AC.

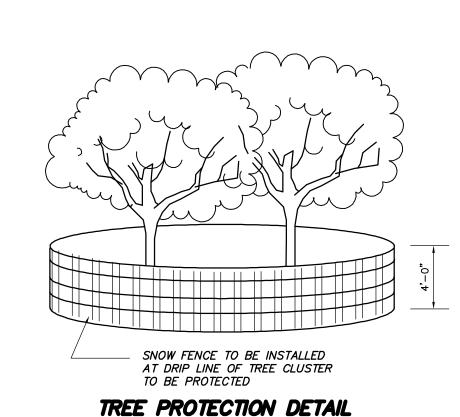



YANNACCONE VILLA & ALDRICH, LLC

CHESTER, NEW JERSEY 07930
PHONE: 908-879-6646
FAX: 908-879-8591
N.J. STATE BOARD FOR P.E. & P.L.S. CERTIFICATE
OF AUTHORIZATION No. 24GA27934500

460 MAIN STREET, P.O. BOX 459

RYAN L. SMITH DATE:

NEW JERSEY LICENSED PROFESSIONAL ENGINEER
AND LAND SURVEYOR No. 42575

NOT VALID WITHOUT SIGNATURE AND RAISED SEAL

O. DATE REVISION

PROJECT TITLE:

LOT 13 ~ BLOCK 62.09

TOWNSHIP OF CHATHAM

MORRIS COUNTY, NEW JERSEY

SHEET TITLE :

DETAIL SHEET 1

CHOWDHURY

PROPERTY

93 SUNSET DRIVE

DRAWN BY:	DATE:
RL11	JULY 7, 2023
CHECKED BY:	SCALE:
RL5	1" = 20'

W.O. *222096*

F.B. *492/138*

FILE:

FILE PATH: M:\SEPTIC\DATA\222000\222096 FILE NAME: LOT13—LDPRLH.DWG

SHEET **4** OF **5**

